

# PROJECT SUMMARY and BID OPTIONS DRAWING INDEX

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G002

G003

G004

A001

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AD101

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SHEET NO SHEET NAME

COVER SHEET

LIFE SAFETY PLANS

PARTITION TYPES

DRAWING INDEX AND CODE ANALYSIS

ACCESSIBILTY COMPLIANCE AND MOUNTING

ABBREVIATIONS AND SYMBOLS LEGEND

DEMO FLOOR PLANS - FIRST FLOOR

FLOOR PLANS- FIRST FLOOR

FLOOR PLANS- SECOND FLOOR

FLOOR FINISH PLAN - FIRST FLOOR

FLOOR FINISH PLAN - SECOND FLOOR

REFLECTED CEILING PLAN - FIRST FLOOR

DEMO FLOOR PLANS - SECOND FLOOR

The Seward Visitor Center is to be renovated as shown in the following documents
to accommodate the new Exhibit Space on the first floor and rehabilitate the center
for accessibility. The scope of the work on the interior will include the following:
<ul> <li>reorganization of the existing spaces to meet the needs of the visitors of the</li> </ul>

building and the employees of the National Park Service an elevator addition that also includes additional storage space that is accessed

from the exterior only · new mechanical space with access from the exterior of the building a remodeled theater space
 new mens and womens bathrooms, janitor closet and storage

new floor and wall finishes throughout the floor

· new siding on the exterior of the building new metal roof

BID OPTIONS Bid Option 1: The replacement of all existing windows with new fiberglass windows

CODE ANALYSIS

The following information shall be used as reference for determining the projects general conformance to the below listed codes. No deviation is allowed unless approved by the Architect in writing. The following Codes were used:

International Building Code 2012 Edition International Mechanical Code 2009 Edition International Energy Conservation Code (IECC) 2006 Edition [Climate Zone 7] 2009 Edition Uniform Plumbing Code International Fire Code 2009 Edition National Electrical Code 2011 Edition Architectural Barriers Act 2004 Edition Accessible and Usable Buildings 2009 Edition and Facilities (ICC/ANSI A117.1)

All requirements will be met of the Energy Conservation Requirements per the IECC Section 502 and IECC Tables 502.2(1) and 502.3 Climate Zone 7, including local amendments

Location: 2100 Seward Highway Seward, AK 99664

International Building Code (IBC) 2012 Edition

Chapter 3 - USE AND OCCUPANCY CLASSIFICATION

Section 302.1 - General
This building has been designated to include the following occupancy groups:

- Assembly: Group A-3
- 2. Business: Group B

Section 303.4 – Assembly Group A-3

The Lecture Hall and Exhibition Space will be considered as A-3

### Section 304.1 – Business Group B

All offices, miscellaneous storage, mechanical, and their respective support spaces will be designated as B occupancies

#### Chapter 4 - SPECIAL DETAILED REQUIREMENTS BASED ON USE AND OCCUPANCY There are no requirements within this Chapter that apply

Chapter 5 - GENERAL BUILDING HEIGHTS AND AREAS

Section 503.1 - General (Table 503- Type VB, fully sprinklered) The type of construction for all applicable occupancies as well as their corresponding tabular areas. per floor are as defined on sheet G001 in the set of drawings.

The maximum area allowed will be based on the tabular values of 503 as follows:

- 1. Type VB, Group A3-1 Story with 6000 sq.ft
- 2. Type VB, Group B2- 2 Story with 9000 sq.ft

<u>Section 504.2 – Automatic Sprinkler system increase</u>
This building will be equipped throughout with an approved automatic sprinkler system in accordance with Section 903.3.11 and therefore the maximum building height per Table 503 is increased by 20 feet and the maximum number of stories is increased by one- the values are as follows:

- 1. Type VB, Group A3- 2 Story with 6000 sq.ft
- 2. Type VB, Group B2- 3 Story with 9000 sq.ft

These increases are permitted in addition to the building area increase in accordance with Section 506.2 and 506.3

### Section 505 Mezzanines

There are no requirements within this section that apply

<u>Section 506.1 General</u> Maximum Allowable Areas per Occupancy is as Follows:

Group A3:  $\{6,000 + [6,000 \times .75] + [6,000 \times 2]\} = 22,500$  allowable sq ft per floor Group B2:  $\{9,000 + [9,000 \times .75] + [9,000 \times 2]\} = 33,750$  allowable sq ft per floor Actual Area First Floor = 2,870 sf Actual Area Second Floor = 1,387 si = 4,257 sf

### Section 506.2 Frontage Increase

Minimum distance to a property lines is 20'-0". This building has 100% of its perimeter on a public way or open space having a minimum width of 20 feet.

SHEET

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A107

A201

A202

A301

A302

A303

A304

A401

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A501

A502

A503

A601

A602

S001

SHEET NO SHEET NAME

**ROOF PLAN** 

EXTERIOR ELEVATIONS

EXTERIOR ELEVATIONS

BUILDING SECTIONS

ELEVATOR SECTIONS

INTERIOR FLEVATIONS

ENLARGED PLANS

OPENING DETAILS

DOOR SCHEDULE

FINISH SCHEDULE

GENERAL NOTES

DETAILS.

**DETAILS** 

WALL SECTIONS

WALL SECTIONS

REFLECTED CEILING PLAN - SECOND FLOOR

If = .75 [equation 5-2].

#### 506.3 Automatic Sprinkler System Increase

Total

The building is being equipped throughout with an approved automatic sprinkler system in accordance to with Section 903.3.1.1 and therefore the building area limitation in Table 503 is permitted to be increased an additional 200%

These increases are permitted in addition to the height and story increases in accordance with Section 504.2 The Is = 200 at the building's two story construction.

### Section 507 Unlimited Area Buildings

There are no requirements within this section that apply

### Section 508 Mixed Use and Occupancy

Section 508.1 General

Each portion of the building will be individually classified in accordance to Section 302.1. This building contains more than one occupancy group (Assembly-A3 and Business-B), the building or portion thereof shall comply with the provisions of Section 508.2 and 508.3

Section 508.2 Accessory occupancies

Accessory occupancies are those occupancies that are ancillary to the main occupancy of the building or portion thereof. The portion of this building that is classified as a Business Occupancy (B) will be considered an accessory occupancy and will comply with the provisions of Sections 508.2.1 through 508.2.5.3

# Section 508.3 Non-separated occupancies

Buildings or portions of buildings that comply with the provisions of this section shall be considered as nonseparated occupancies.

### Section 508.3.1 Occupancy classification

Non-separated occupancies shall be individually classified in accordance with Section 302.1. The requirements of this code shall apply to each portion of the building based on the occupancy classification of that space. In addition....to the total non-separated occupancy area.

Section 508.3.2 Allowable building area and height
The allowable building area and height of the building or portion thereof shall be based on the most restrictive allowances for the occupancy groups (Occupancy Group A3- 2 story, 22,500 sf) under consideration for the type of construction of the building in accordance with Section 503.1

### Section 508.3.3 Separation

No separation is required between occupancies

### Section 509 Special Provisions

There are no requirements within this section that apply

### Chapter 6 - TYPES OF CONSTRUCTION

Section 602.1 - General Construction (Table 601 and Table 602) This building will be designated as: Type VB (Non-Rated) construction, fully sprinklered throughout Table 601 – Fire Resistance Rating Requirements for Building Elements

Structural Frame Exterior Bearing Walls 0 HR 0 HR Interior Bearing Walls Interior Non Bearing Walls 0 HR Floor Construction 0 HR Roof Construction

Based on the proposed site parameters with frontage clearance greater than 30 feet on all open sides the exterior walls (Table 602) require no fire resistance ratings.

X>30 = 0 HR for all Types

#### Chapter 7 - FIRE AND SMOKE PROTECTION FEATURES Section 704 – Fire-Resistance Rating of Structural Members

#### Section 708.5 FXTFRIOR WALLS

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SUB

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S401

S501

S502

M001

M002

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SHEET NO SHEET NAME

STATEMENT OF SPECIAL INSPECTIONS

LEGEND ABBREVIATIONS AND SCHEDULES

FIRST FLOOR PLUMBING DEMOLITION PLAN

FIRST FLOOR HVAC DEMOLITION PLAN

SECOND FLOOR HVAC DEMOLITION PLAN

SECOND FLOOR PLUMBING DEMOLITION PLAN

CRAWL SPACE DEMOLITION PLAN

FOUNDATION PLAN

ROOF FRAMING PLAN

BUILDING SECTIONS

ELEVATOR DETAILS

FRAMING DETAILS

FRAMING DETAILS

SCHEDULES

FOUNDATION DETAILS

FIRST FLOOR FRAMING PLAN

SECOND FLOOR FRAMING PLAN

Where exterior walls serve as a part of a required fire resistance rated shaft or exit enclosure, or separation, such walls shall comply with the requirements of Section 705 for exterior walls and the fire-resistance-rated enclosure or separation requirements shall not apply

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SHEET NO SHEET NAME

REMODEL PLAN

REMODEL PLAN

REMODEL PLAN

MECHANICAL DETAILS

MECHANICAL DETAILS

LEGEND

SCHEDULES

Section 713.4 Fire Resistance rating

Shaft enclosures shall have a fire resistance rating of not less than 2 hours where connecting four stories or more, and not less than 1 hour where connecting less than four stories.

### Section 713.14.1 ELEVATOR LOBBY.

Exception 4

Enclosed elevator lobbies are not required where the building is protected by an automatic sprinkler system installed in accordance with Section 903 3 1 1 or 903 3 1 2

#### Chapter 9 - FIRE PROTECTION SYSTEMS

#### Section 906.1 Where required

Portable fire extinguishers shall be installed in the following locations. Within 75' of travel distance

# Chapter 10 - MEANS OF EGRESS (And Table 1003.2.2.2 and 1003.2.3)

## Section 1003.2 - Ceiling Height

The means of egress shall have a ceiling height of not less than 7 feet 6 inches

### Section 1003.6 - Means of egress continuity

Continuity: the path of egress travel along a means of egress shall not be interrupted by any building element other than a means of egress component.

### Section 1003.7 - Elevators, escalators, and moving walks

Elevators: Elevators shall not be used as a component of a required means of egress from any other part of the building

### Section 1004.1.1 - Areas without fixed seating

The number of occupants shall be computed at the rate of one occupant per unit of area as prescribed in Table

Accessory storage areas, mechanical equipment rooms	300 gros
Business areas and workroom	100 gros
Assembly without fixed seats	_
Concentrated (chairs only- not fixed)	7 net
Assembly	
Exhibit Gallery and Museum	30 net

Occupant Loads:	
First Floor Business: First Floor Exhibit Gallery: First Floor Assembly without fixed seats: First Floor Storage/Mechanical:	= 5 occ = 58 occ = 59 occ = 5 occ
First Floor Total	= 127 occ
Second Floor Business: Second Floor Storage/Mechanical	= 10 occ = 1 occ
Second Floor Total	= 11 occ
Total Building Occupancy	= 138 occ

Section 1007.1 Accessible means of egress required
Accessible means of egress shall comply with this section. Accessible spaces shall be provided with not less than one accessible means of egress. Where more than one means of egress are required by Section 1015.1 or 1021.1 from any accessible space, each accessible portion of the space shall be served by not less than two accessible means of egress

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SHEET

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SUF

E102

F103

E104

E201

F202

E301

F401

F402

E501

F601

E602

F701

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SHEET NO SHEET NAME

FLOOR

FLOOR

EXHIBIT SCHEDULE

FIRST FLOOR

PANEL SCHEDULES

DETAILS

POWER & SIGNAL DEMOLITION PLAN - FIRST

LIGHTING DEMOLITION PLAN - SECOND FLOOR

POWER & SIGNAL DEMOLITION PLAN - SECOND

LIGHTING REMODEL PLAN - FIRST FLOOR AND

LIGHTING REMODEL PLAN - SECOND FLOOR

POWER REMODEL PLAN - FIRST FLOOR

SIGNAL REMODEL PLAN - FIRST FLOOR

ELECTRICAL ONE-LINE DIAGRAMS

POWER REMODEL PLAN - SECOND FLOOR

SIGNAL REMODEL PLAN - SECOND FLOOR

ENLARGED POWER & SIGNAL REMODEL PLAN -

FIRE ALARM & SECURITY ONE-LINE DIAGRAMS

Exception 1 Applies: Accessible means of egress are not required in alterations to existing buildings

FIRST FLOOR LINDER FLOOR PLUMBING

FIRST FLOOR ABOVE FLOOR PLUMBING

SECOND ELOOR ABOVE ELOOR PLUMBING

FIRST FLOOR HVAC REMODEL PLAN

SECOND FLOOR HVAC REMODEL PLAN

MECHANICAL PLANS AND SCHEMATICS

FIRST FLOOR FIRE PROTECTION PLAN

SECOND FLOOR FIRE PROTECTION PLAN

LIGHTING DEMOLITION PLAN - FIRST FLOOR

Section 1009.2.1 Interior Exit Stairs Interior exit Stairsy shall lead directly to the exterior of the building or shall be extended to the exterior of the building with an exit passage way conforming to the requirements of Section 1023, except as permitted in Section 1027.1

#### Section 1009.3.1.2 Fire-resistive rating

Exist access stairway enclosures shall have a fire-resistive rating of not less than 2 hours where connecting four stories or more, and not less than 1 hour where connecting less than four stories. The number of stories connected by the exit access stairway enclosures shall include any basements, but not any mezzanines. Exit access stairway enclosures shall have a fire resistive rating not less than the floor assembly penetrated, but need not exceed 2 hours.

#### Section 1009.4 Width

The width of the stairways shall be determined as specified in Section 1005.1, but such width shall not be less than 44 inches

Exception 1 Applies: Stairways serving and occupant load of less than 50 shall have a width not less than 36 inches

### Section 1021.2 Exits from stories

Two exits, or exit access stairway or ramps providing access to exits, from any story or occupied roof shall be provided where one of the following conditions exists:

Condition 2 Applies: The exit access travel distance exceeds that specified in Table 1021.2 (1) or 1021.2 (2) as determined in accordance with the provisions of Section 1016.1

The building does not exceed Second Story- Occupancy B- Maximum occupants 29 and 75'-0" feet maximum exit travel distance, therefore only (1) exit is required from the second floor. Three exits are provided from the first floor

### Chapter 29 - Plumbing Systems

### Section 2902.1 – Minimum number of fixtures

Plumbing fixtures shall be provided for the type of occupancy and in the minimum number shown in Table

### Assembly (A3)-

Water Closets: For male: 1 per 125

For female: 1 per 65

127/2 = 64 occupants for male and female For male and female: 1 required, 1 water closets provided

#### Lavatories: For male and female: 1 per 200 127/2 = 64 occupants for male and female For male and female: 1 required, 1 provided

Drinking Fountains: 1 per 500 1 required. 2 provided

Other: 1 service sink

DESIGNED:

TECH REVIEW

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1 required Business (B)-

1 unisex provided

SUB SHEET NO.

Water Closets: For male and female: 1 per 25 for the first 50 and 1 per 50 for the remainder exceeding 50. separate facilities not required when serving an occupant load of 15 or less IBC 2902.2

RIM ARCHITECTS
645 G STREET, SUITE 400 ANCHORAGE, AK 99501 (907)-258-7777
PALMER 111WEST EVERGREEN AVE. PALMER, AK 99645 (907)-258-7777
CORPORATE NO. AECL1227.

G002

SEWARD VISITOR CENTER REHAB KENAI FJORDS NATIONAL PARK

TITLE OF SHEET


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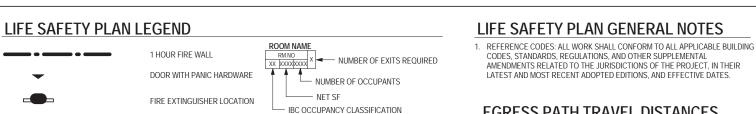
DRAWING INDEX AND CODE ANALYSIS

# **GENERAL PROJECT NOTES:**

- I. CONTRACT DOCUMENTS: THE CONTRACT DOCUMENTS FOR THIS PROJECT , TITLED KENAI FJORDS VISITOR CENTER, DATED 09.20.2016. CONSIST OF THE DRAWINGS AND SPECIFICATIONS FROM ARCHITECTURAL, STRUCTURAL, MECHANICAL AND ELECTRICAL. ALL INFORMATION HEREIN SHALL BE TREATED EQUALLY, WITHOUT ANY HIERARCHY, AND/OR ORDER OF PRECEDENCE, UNLESS OTHERWISE
- 2. ELECTRONIC MEDIA: THE CONSTRUCTION DOCUMENTS HAVE BEEN PREPARED UTILIZING ELECTRONIC DRAFTING FORMATS OF AUTODESK REVIT VERSION 2015 THE AVAILABILITY OF ELECTRONIC BASE FLOOR PLANS, AND/OR ANY OTHER RELATED DOCUMENT FOR USE BY THE GENERAL CONTRACTOR FOR USE ON THIS SPECIFIC PROJECT IS CONDITIONALLY GRANTED THROUGH PERMISSION OF THE CONTRACTING OFFICER.
- 3. VERIFY CONDITIONS: THE CONTRACTOR SHALL VERIFY ALL PROJECT- RELATED NEW AND/OR EXISTING CONDITIONS INCLUDING DIMENSIONS PRIOR TO THE COMMENCEMENT OF WORK PROMPTLY NOTIFY THE CONTRACTING OFFICER IN WRITING OF DISCREPANCIES AND/OR UNKNOWN CONDITIONS OBSERVED.
- 4. DRAWING FORMAT: THESE CONSTRUCTION DOCUMENTS HAVE BEEN PRODUCED AT DRAWING SCALES THAT RELATE TO THEIR FULL SIZE FORMAT 22"x34" ANY DEVIATIONS TO THIS FORMAT SIZE WILL PRODUCE DRAWINGS OUTSIDE OF THE SCALE LIMITS INDICATED DRAWING REPRODUCTIONS AT ANY FORMAT SHOULD NOT BE SCALED FOR DIMENSIONAL ACCURACY USE GRAPHIC SCALES ACCORDINGLY.
- 5. PREPARATION OF DOCUMENTS: THESE CONTRACT DOCUMENTS HAVE BEEN PREPARED FROM CONSTRUCTION DOCUMENTS DATED 06/85 PROVIDED BY THE CONTRACTING OFFICER ANY DEVIATION FROM THESE CONDITIONS SHOULD BE BROUGHT TO THE ATTENTION OF THE DEPARTMENT FOR RESOLUTION.

  6. SELECTIVE DEMOLITION: THIS PROJECT INVOLVES THE SELECTIVE DEMOLITION OF EXISTING FACILITIES THE CONTRACTOR IS RESPONSIBLE FOR THE REMOVAL AND DISPOSAL AS MANDATED IN THE
- DOCUMENTS ALL DEMOLISHED MATERIALS WILL BECOME THE PROPERTY OF THE CONTRACTOR AND DISPOSITION OF ALL SUCH MATERIALS MUST BE TAKEN INTO CONSIDERATION
- 7. HAZARDOUS MATERIALS: IT IS NOT EXPECTED THAT HAZARDOUS MATERIALS WILL BE ENCOUNTERED IN THE WORK, IF SUSPECTED HAZARDOUS MATERIALS ARE ENCOUNTERED, DO NOT DISTURB; IMMEDIATELY NOTIFY DEPARTMENT HAZARDOLIS MATERIALS WILL BE REMOVED BY THE DEPARTMENT LINDER SEPARATE CONTRACT
- 8. PROJECT PERMITTING: THE CONTRACTOR SHALL OBTAIN ALL REQUIRED BUILDING PERMITS.
- 9. SITE SAFETY: CONTRACTOR IS RESPONSIBLE FOR ALL PROJECT RELATED SAFETY MEASURES ON-SITE, DURING THE PROJECTS CONSTRUCTION PERIOD NOTIFY THE GENERAL CONTRACTOR AND/OR THE DESIGNATED "SAFETY OFFICER" AT ONCE SHOULD ANY SAFETY RELATED CONCERNS BE OBSERVED ON-SITE.



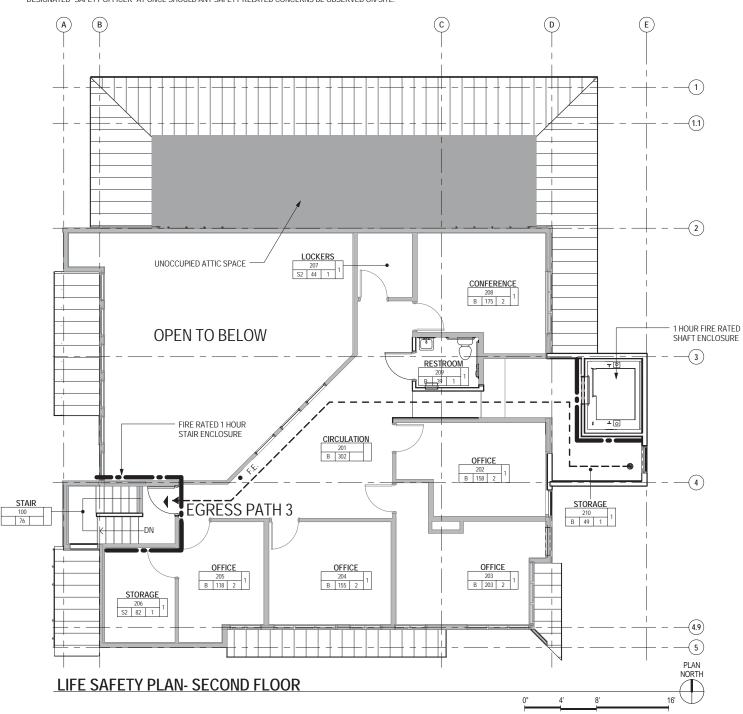

OCCUPANT LOAD THRU EXIT

EXISTING WALL CONSTRUCTION TO REMAIN- REFER TO PARTITION TYPES SHEET A002 FOR ADDITIONAL INFORMATION

NEW CONSTRUCTION - REFER TO PARTITION TYPES SHEET

CODES, STANDARDS, REGULATIONS, AND OTHER SUPPLEMENTAL AMENDMENTS RELATED TO THE JURISDICTIONS OF THE PROJECT, IN THEIR LATEST AND MOST RECENT ADOPTED EDITIONS, AND EFFECTIVE DATES.

# EGRESS PATH TRAVEL DISTANCES

PMIS/PKG NO.

SHEET

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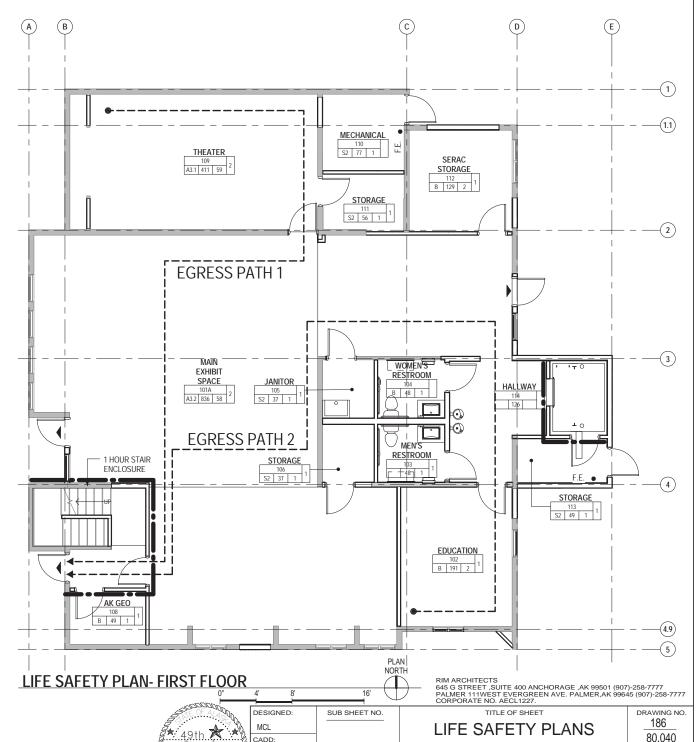
184638

SEWARD VISITOR CENTER REHAB KENAI FJORDS NATIONAL PARK

EGRESS PATH NAME EGRESS PATH- TOTAL DISTANCE

98' - 2" 117' - 0"

62' - 6"




G003


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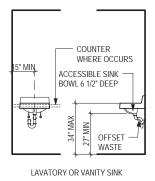
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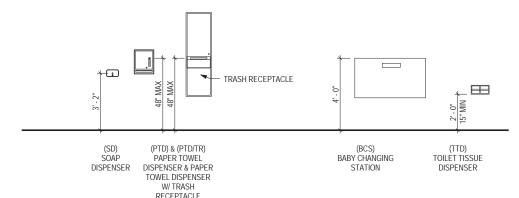
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TECH REVIEW








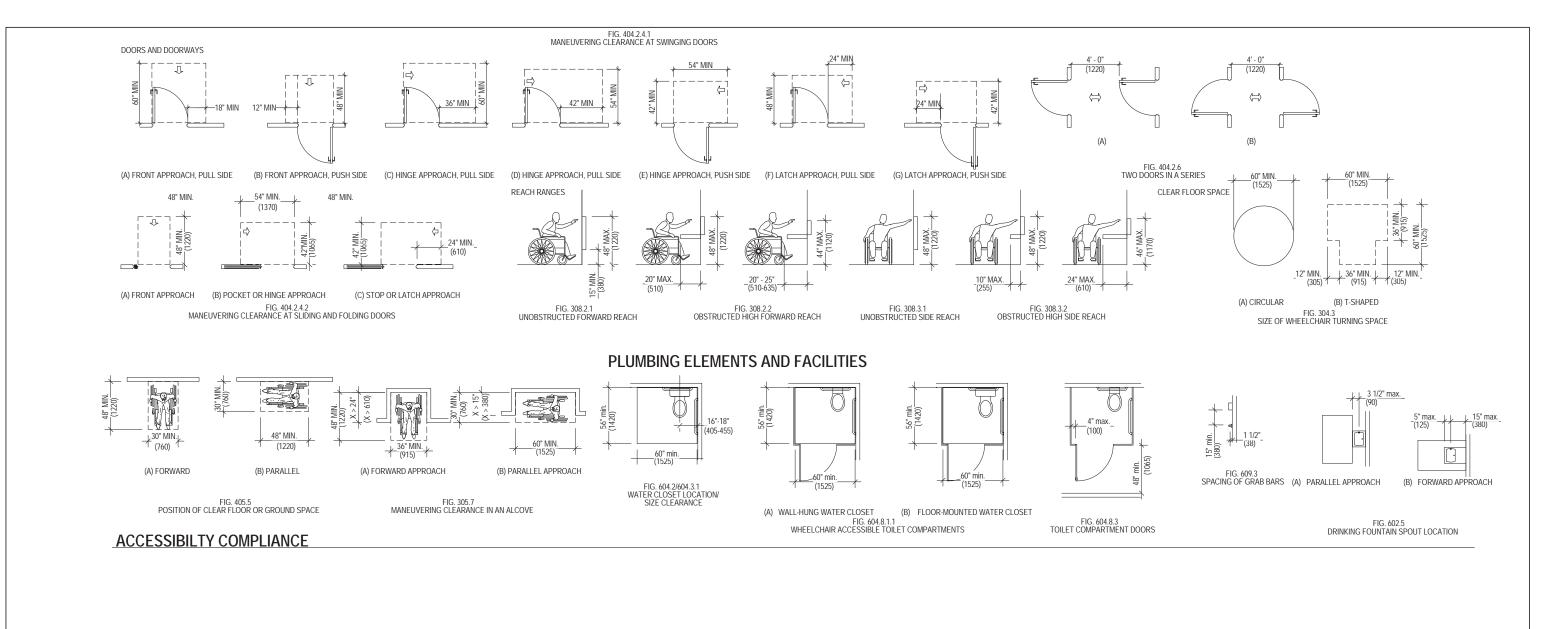
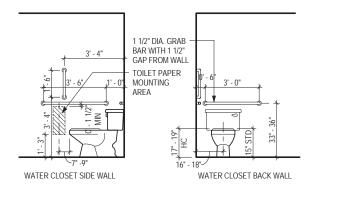
# PLUMBING FIXTURE AND TOILET ACCESSORY MOUNTING HEIGHTS

RIM ARCHITECTS
645 G STREET, SUITE 400 ANCHORAGE ,AK 99501 (907)-258-7777
PALMER 111WEST EVERGREEN AVE. PALMER,AK 99645 (907)-258-7777
CORPORATE NO. AECL1227.

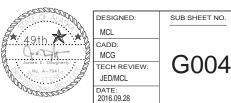

TITLE OF SHEET						
ACCESSIBILTY						
COMPLIANCE AND						
MOUNTING HEIGHTS						
SEWARD VISITOR CENTER REHAB KENAI FJORDS NATIONAL PARK						

186 80,040 PMIS/PKG NO. 184638 SHEET 4 OF 73

#### ABBREVIATIONS LEGEND **MATERIALS LEGEND** CONCRETE PUBLIC ACCESS TREAD . CMU ANCHOR BOLT INSIDE DIAMETER PC PCC PEND PERIM PH PLAS PLBG PIECE PRECAST CONCRETE TOWEL BAR TO BE DETERMINED ABS STYRENE ABV ACRYLONITRILE BUTADIENE INCLUDED INSULATED METAL PANEL EXTERIOR INSULATION FINISH SYSTEM EXPANSION JOINT FI EVATION PERIMETER TELEPHONE AIR CONDITIONING INFO INSUL INFORMATION ELAST ELEC ELEV EMER ENCL EPB EPDM ES EQ EQUIP EOS EWC EXH EXP EXPN EXT (E) FLASTOMERIC TEMP TER T&G THRES THRU THK TK BD TMPD TOC TOM TOP TOS TOW TPD TPH TS TSH TSTAT TEMPERATURE ASPHALTIC CONCRETE ACOUSTICAL CEILING PANEL INSULATION/INSULATED FLECTRICAL INTERIOR INVERT CLASSIFIED COMPACTED FILL PLUMBING PROPERTY LINE PLASTIC LAMINATE PLANTIC LAMINATE PANEL PARE PARE PROPERTY PREFABRICATE PAINT PAPER TOWEL DISPENSER AND RECEPTACLE PARTITION TONGUE AND GROOVE THRESHOLD THRESHOLD THROUGH THICKNESS TACK BOARD TEMPERED TOP OF CURB TOP OF MASONRY TOP OF SLAB TOP OF WALL TOP OF SLAB TOP OF WALL TOP OF SLAB TOP OF WALL TOLET PAPER HOLDER TUBE STEEL TOWEL SHELF THERMOSTAT TONGLE AND GROOVE SAND, MORTAR, PLASTER, AREA DRAIN ELEVATOR EMERGENCY ENCLOSURE ELECTRICAL PANEL BOARD ETHYLENE PROPYLENE DIENE MONOMER ADDITIONAL ACCESSIBLE DRINKING FOUNTAIN ADJACENT ADDL ADF ADJ AFF TILE BACKER BOARD ETHYLENE PROPYLENE DIEN EACH SIDE EQUIAL EQUIPMENT EDGE OF SLAB ELECTRIC WATER COOLER EXHAUST EXPOSED EXPANSION EXTERNOR EXISTING ABOVE FINISH FLOOR I-ROX JUNCTION BOX ABOVE FINISH SLAB AGGREGATE Ī⊞ FARTH LINCLASSIFIED FILL BATT INSULATION ALLIMINIUM PT PTD PTDR K PTN PTR PVC PVMT PARTITION PAPER TOWEL RECEPTACLE POLYVINYL CHLORIDE RIGID INSULATION FINISHED WOOD KD KNOCK DOWN KITCHEN KNOCK-OUT PAVEMENT THERMOSTAT TELEVISION KO KW KWH BARBEQUE METAL BCS BD BFF BKBD BLDG BLK BLKG BABY CHANGING STATION TYPICAL TOILET PLYWOOD/MDF KILOWATT HOUR BOARD BELOW FINISH FLOOR QT OLIARRY TILE BACK BOARD GLASS GYPSUM WALL BOARD LENGTH LABORATORY UNIFORM BUILDING CODE BLOCKING RISER RADIUS RETURN AIR RUBBER BASE RESILIENT COVE BASE BM BOD BOT F BOT UNDERCUT UNDERGROUND UNGD BOTTOM OF DECK E CERAMIC TILE, VCT OR ACOUSTICAL TILE/PANEL LÄVÄTÖRY POUNDS PER SQUARE FOOT LANDING LINEAR FOOT LEFT HAND LOCKER LOWS LEG VERTICAL LOCATION LIGHT LIVING ROOM LOUVER BOTTOM FACE UNIT HEATER UNDERWRITERS LABORATORY FIRE EXTINGUISHER CABINET UNFIN UNO UR BEDROOM FURNITURE, FIXTURES AND EQUIPMENT UNFINISHED UNLESS OTHERWISE NOTED ROBE HOOK REFLECTED CEILING PLAN ROOF DRAIN BEARING BRACKET BASEMENT FIRE HOSE CABINET BTWN BUR RECESSED BLIII T-LIP ROOFING FINISH GRADE REFRIGERATOR REFLECTED REGISTER FIXTURE VARIES VALVE BOX FOLDING REINFORCE FLOORING VCT VERT VEST VINYL COMPOSITION TILE RECOMMENDATIONS FLOOR REQUIRED VERTICAL VESTIBULE SYMBOLS LEGEND CABINET CATCH BASIN FLUORESCENT RESILIENT FLOOR SINK VOL VP VTR VWC REST ROOM VOLUME CEM CER CFCI FACE OF CONCRETE CEMENT VENEER PLASTER REVISION FACE OF FINISH RUBBER TILE FLOOR VENT THROUGH ROOF ROOM DESIGNATION WALL TYPE CONTRACTOR FURNISHED METER SQUARE METERS MATERIAL MAXIMUM MACHINE BOLT ROOM NAME FACE OF MASONRY XXx M M2 MATL MAX MB MBR MC MECH MEMB MEZZ MFR MH MID ROOFING VINYL WALL COVERING CONTRACTOR INSTALLED CORNER GUARD FACE OF STUD RM NO CG CMPST CI RAILING FACE OF WALL FIRE PROOF RIGHT HAND COMPOSITE CAST IRON ROUND ROOM ROUGH OPENING CAST IN PLACE CONTROL JOINT FIRERGI ASS REINFORCED MASTER BEDROOM MEDICINE CABINET PLASTIC FIRE RETARDANT FREEZER DOOR DESIGNATION XXXX (XX)-----GRIDLINE RAIN WATER I FADER FRT FRZ FT FTD FTG FURG FUT MECHANICAL CLG CLO CLR CMU CNTR CO CONC CONC CONC CONSTR CONT CONTR COORD COPT CSK CT CTR CUH CULT CW CEILING FREEZER FEET FACIAL TISSUE DISPENSER FOOTING FURRING FUTURE MEMBRANE MEZZANINE WC WCLR WALL COVERING CLEAR CONCRETE MASONRY UNIT WATER COOLER MANUFACTURER SOUTH SUPPLY AIR WD WDSP MANHOLE WASTE DISPOSER SOUND ATTENUATION BLANKET EXTERIOR ELEVATION DESIGNATION X'XX" AFF CEILING HEIGHT DESIGNATION WDW WF MIDDLE SPLASH BLOCK WIDE FLANGE MIN MISC MLDG MM MO MOD MP SOLID CORE CONCRETE CONDITION CONNECTION CONSTRUCTION CONSTRUCTION CONTINUE/CONTINUOUS CONTRACTOR COORDINATE COPPER CORRIDOR CARPET COUNTERSINK CERAMIC TILE CENTER MISCELLANEOUS SCHED SCHEDULE WH W/O WP WR WATER HEATER SCD SCP SCR SCRN SD SECT SED MOULDING SEAT COVER DISPENSER MILLIMETER SCUPPER DET\_NO SIM NATURAL GAS WATERPROOF / WATERPROOFING SHOWER CURTAIN ROD MASONRY OPENING GAUGE WATER REPELLENT EQUIPMENT DESIGNATION DETAIL DESIGNATION GALV GB GEN GFGI GALVANIZED GRAB BAR WAINSCOT WET STAND PIPE METAL PANEL SMOKE DETECTOR MOISTLIRE RESISTANT GENERAL GOVERNMENT FURNISHED / MOUNTED SEE FLECTRICAL DRAWINGS. SEE LECTRICAL DRAWINGS SOUARE FEET SHEAT SHOWER SHEATHING SHEAVING SIMILAR SLOPE SLIDING SEALANT SHEET METAL SANITARY NAPKIN DISPENSER SANITARY NAPKIN RECEPTACLE SPACING SPECIFICATION SPERINKLER GOVERNMENT FURNISHED / GOVERNMENT INSTALLED GLASSFIBER REINFORCED GYPSUM GLASSFIBER REINFORCED CONCRETE GLASSIGLAZING GLUE LAMINATED WOOD GALLONS PER IMIUTE GRANITE GYPSUM SHEATHING BOARD GATE VALVE GLAZED WALL TILE GYPSUM WALL BOARD WELDED WIRE FABRIC MOUNTING GFRG GFRC MULLION MUNTIN MICROWAVE $\langle \chi \chi \rangle$ BUILDING SECTION DESIGNATION OPENING DESIGNATION GL GLU LAM GPM GRAN GSB GTV GWT GYP GWB CENTER CABINET UNIT HEATER CULTURED COLD WATER PIPING NORTH NON-FROST SUSCEPTIBLE NOT IN CONTRACT NUMBER NOMINAL NOT TO SCALE FURNITURE DESIGNATION WALL SECTION DESIGNATION XXXX N NFS NIC NO NOM NTS $\propto$ SPRINKLER SPEAKER REVISION DESIGNATION INTERIOR ELEVATION DESIGNATION DEEP/DEPTH HIGH HOSE BIBB DEGREE DEPARTMENT OVERALL OBSCURE ON CENTER OUTSIDE DIAMETER OWNER FURNISHED/ CONTRACTOR INSTALLED OWNER FURNISHED/ OWNER INSTALLED OVERFLOW DRAIN OVER HAND OPPOSITE HAND OPPOSITE OPPENBILE OVER HEAD HC HCP HD HDBD HDW HDWD HM HORIZ DETAIL OA OBS OC OD OF/CI SEE MECHANICAL DRAWINGS DRINKING FOUNTAIN HANDICAPPED HEAD SEAMLESS DIA DIAG DIM DISP MATCHLINE DIAMETER PLAN KEYNOTE HARDBOARD SOLID SURFACE \_\_\_\_\_ SS STA STD STL STOR STR STRUCT SURR SUSP SVCE SW SYMM SYS STATION DIMENSION HARDWOOD STANDARD STEEL DISPENSER DN DR DS DSP DW DWG DWR DOWN OF/OI DOOR HAND SINK STRINGERS DOWNSPOUT OFD OH OPH OPNG OPP OPR OVHD BREAK LINE DATUM DESIGNATION DRY STANDPIPE HVAC HEATING VENTUATION AND SURROUND DISHWASHER SUSPENDED DRAWING SERVICE DRAWER SYMMETRICAL PLAN NORTH/NORTH GRAPHIC SCALE **VIEW NAME 1** - TITLE DESIGNATION RIM ARCHITECTS NIM ARCHITECTS 645 G STREET, SUITE 400 ANCHORAGE ,AK 99501 (907)-258-7777 PALMER 111WEST EVERGREEN AVE. PALMER,AK 99645 (907)-258-7777 CORPORATE NO. AECL1227. DESIGNED: SUB SHEET NO. TITLE OF SHEET MCL ABBREVIATIONS AND CADD. SYMBOLS LEGEND MCG A001 TECH REVIEW TR/MCL

DRAWING NO. 186

80.040

PMIS/PKG NO.

SHEET

5 of 73


184638

SEWARD VISITOR CENTER REHAB


KENAI FJORDS NATIONAL PARK

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2016.09.28

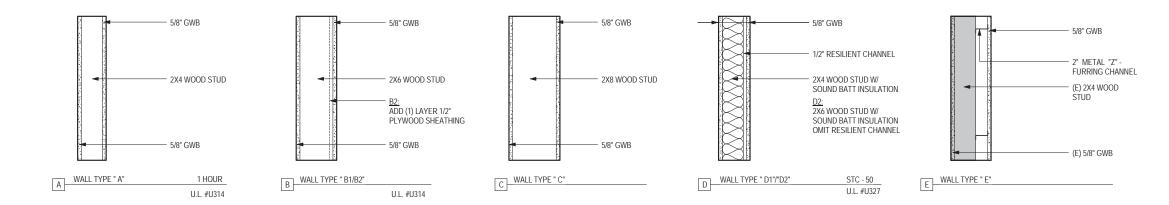

# **PARTITION TYPES**

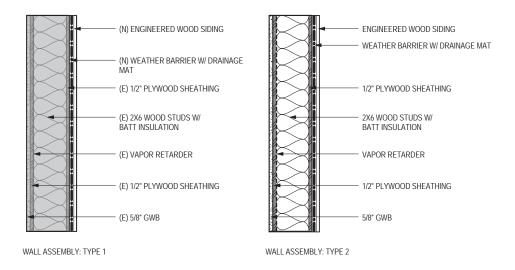

# **EXTERIOR WALL ASSEMBLIES**

# PARTITION TYPE GENERAL NOTES

1. PARTITION TYPES ARE NOTED ON THE ENLARGED FLOOR PLANS. REFER TO THE A001 SERIES FOR LOCATION AND EXTENT OR LIMITS OF RATED PARTIONS.

2. REFER TO EXTERIOR WALL SECTIONS AND DETAILS FOR ADDITIONAL WALL/PARTITION FRAMING NOT SPECIFICALLY IDENTIFIED ON FLOOR PLANS.

3. ALL FIRE RATED ASSEMBLIES ARE BASED ON IBC, UL OR GYPSUM ASSOCIATION FIRE RESISTANCE DESIGN MANUAL. FIRE RATED PARTITIONS ARE TO BE CONSTRUCTED IN ACCORDANCE TO THE REQUIREMENTS OF THE TESTING AGENCY(IES) LISTED. REFER TO SPECIFIC TEST REPORTS FOR REQUIRED COMPONENTS AND ASSEMBLY.

4. ALL ACOUSTIC ASSEMBLIES ARE BASED ON ASTM E 90 TEST PROCEDURES. ACOUSTIC RATED PARTITIONS ARE TO BE CONSTRUCTED IN ACCORDANCE WITH THE REQUIREMENTS OF THE APPROVED TESTING AGENCY(IES). REFER TO SPECIFIC TEST REPORTS FOR REQUIRED COMPONENTS AND ASSEMBLY.

5. ALL OTHER (NON-STRUCTURAL) PARTITIONS ARE TO BE CONSTRUCTED IN ACCORDANCE WITH THE SPECIFICATIONS, MATERIALS MANUFACTERER, AND INDUSTRY STANDARDS.

6. INTERIOR STUDS ARE NON-LOAD BEARING OR SHEAR WALL UNO.

7. ALL GYPSUM BOARD IS TO BE 5/8" THICK, TYPE 'X'- UNO


# WALL PRIORITY LEGEND



ONE HOUR FIRE AND/ OR SMOKE WALL - PRIORITY 3

NOTE: ALL PARTITION TYPES INDICATED, MAY NOT BE USED. REFER TO PLANS FOR ADDITIONAL INFORMATION.

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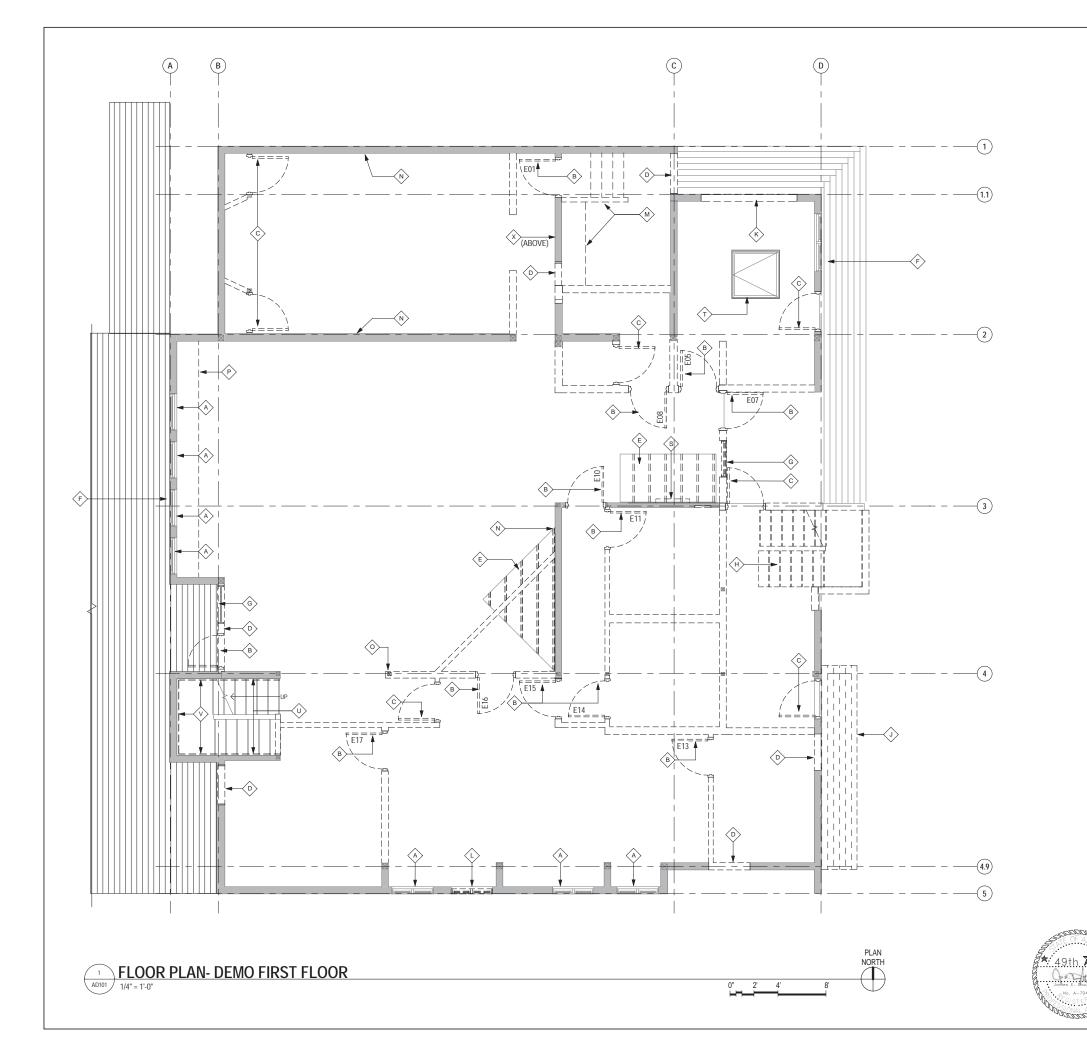
PARTITION TYPES

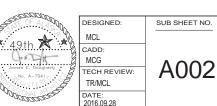SEWARD VISITOR CENTER REHAB KENAI FJORDS NATIONAL PARK

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DRAWING NO.

80.040



# **DEMO PLAN GENERAL NOTES**

- . REFER TO SHEET G001 FOR GENERAL PROJECT NOTES . REFER TO SHEET G002 AND G003 FOR CODE ANALYSIS AND ADDITIONAL LIFE SAFETY GENERAL NOTES
- DIMENSIONING GUIDE: ALL DIMENSIONS ARE TAKEN TO/FROM GRID LINE, FACE OF CONCRETE AND MASONRY, AND FACE OF METAL/WOOD STUD PARTITION, UNLESS OTHERWISE NOTED. CLEAR DIMENSIONS BETWEEN SURFACES WILL BE NOTED WHERE APPLICABLE FROM MATERIAL FINISHES. ALL DIMENSIONS REFERENCED HEREIN ARE IMPERIAL STANDARDS, UNLESS OTHERWISE NOTED. FOR THE PURPOSE OF THIS PROJECT, ALL DIMENSIONS HEREIN SHALL BE TREATED EQUALLY, WITHOUT ANY HIERARCHY, AND/OR ORDER OF PRECEDENCE, UNLESS OTHERWISE NOTED
- REFERENCE ELEVATION: ALL ELEVATIONS NOTED ON THIS PLAN CORRESPOND TO REFERENCE ELEVATION 0:0° AS THE EXISTING FIRST FLOOR LEVEL. DEVIATIONS AND VARIANCES IN THIS ELEVATION MAY EXIST, AS INDICATED. UPPER FLOOR ELEVATIONS TO BE NOTED ACCORDINGLY. NOTE: THIS ASSISTS AND ESTABLISHES NOTED VERTICAL CONTROL AT ALL FLOOR PLANS, REGARDLESS TO FLOOR LEVEL.
- 5. DOOR OPENINGS: ALL DOOR OPENINGS (INCLUDING DOOR, FRAME AND HARDWARE) THAT ARE BEING SHOWN AS DEMOLISHED ARE TO REUSED AND REINSTALLED AS SHOWN ON THE FLOOR PLAN- REFER TO SHEETS A101, A102, AND OPENING SCHEDULE
- ROOM FINISHES: ALL FLOOR FINISHES ARE TO BE DEMOLISHED, EXISTING FIRST FLOOR WALL BASE IS TO BE SALVAGED, PAINTED AND REINSTALLED. CONTRACTOR HAS THE OPTION TO LEAVE IN PLACE OR REMOVE AND REINSTALL- REFER TO SHEETS A103 AND A104 FOR NEW FINISHES.
- REFLECTED CEILING PLAN: REFER TO SHEET A105 AND A106 FOR THE CORRESPONDING RCP FOR THIS AREA
- 8. ALL EXTERIOR SIDING AND EXISTING WEATHER BARRIER TO BE REMOVED- EXISTING SHEATHING TO REMAIN.
- ALL ROOFING AND UNDERLAYMENTS TO BE REMOVED TO THE SHEATHING- EXISTING SUBSTRATE SHEATHING TO REMAIN.
- 10. THE GOVERNMENT WILL BE RESPONSIBLE FOR THE REMOVAL OF ALL STORED ITEMS IN CRAWL SPACE, ATTIC, AND ELSEWHERE, AS WELL AS ALL SHELVING AND FURNITURE ON
- 11. ALL EXISTING COLUMNS IN DEMOLISHED WALLS TO REMAIN UNLESS NOTED OTHERWISE. 12. DEMOLISH ALL EXISTING CEILINGS ON FIRST FLOOR EXCEPT IN ROOM 112 SERAC STORAGE AND 101A MAIN EXHIBIT SPACE.

# **DEMOLITION LEGEND**



EXISTING TO REMAIN



ITEMS TO BE DEMOLISHED- REFER TO SHEET NOTES FOR ADDITIONAL



EXISTING DOOR NUMBER FOR RELOCATION IDENTIFICATION- REFER TO DOOR SCHEDULE ON SHEET A602 FOR WHERE TO REINSTALL



ROOFING AND UNDERLAYMENTS TO BE DEMOLISHED- EXISITNG

# **DEMOLITION SHEET NOTES**

- A EXISTING OPENING TO REMAIN- BID OPTION 1 TO REPLACE THESE OPENINGS WITH NEW
- B EXISTING DOOR, FRAME AND HARDWARE TO BE REMOVED AND REINSTALLED
- C DOOR, DOOR FRAME AND HARDWARE TO BE DEMOLISHED
- D DEMOLISH PORTION OF WALL TO CREATE NEW OPENING- REFER TO FLOOR PLANS FOR
- DEMOLISH FLOOR AND STRUCTURE BELOW- REFER TO STRUCTURAL DRAWINGS FOR
- REMOVE 4x12 DECK BOARDS TO INSTALL NEW SIDING. REINSTALL WHEN DECK BOARD SIDIING
- G EXISITNG SIDELIGHT TO BE REMOVED, SALVAGE FOR REINSTALLATION
- H DEMOLISH STAIRS, FRAMING, HANDRAILS AND ACCESSORIES
- DEMOLISH DECK
- REMOVE WALL INFILL
- DEMOLISH EXISTING WINDOW, SILL AND TRIM- INFILL WITH WALL TYPE "2"
- DEMOLISH RAISED FLOOR AND STAIRS
- DEMOLISH CARPET OR WOOD PANELING PREPARE SURFACE TO RECIEVE NEW FINISH. REFER TO SHEETS A103&A104 FOR ADDITIONAL INFORMATION
- O DEMOLISH COLUMN REFER TO STRUCTURAL DRAWINGS
- DEMOLISH BENCH
- EXISITING CASEWORK- TO BE REMOVED BY THE NATIONAL PARK SERVICE
- REMOVE WATER COOLER AND BOTTLE FILLER STATION, SALVAGE FOR REINSTALLATION IN NEW PLAN- REFER TO DETAIL 1/A401 FOR LOCATION
- EXISTING FLOOR ACCESS HATCH TO REMAIN REFER TO SHEET A101 FOR LOCATION
- DEMOLISH EXISTING HANDRAILS
- DEMOLISH GYPSUM BOARD WALLS OR TOP OF STRINGER TO UNDERSIDE OF STRUCTURE. DEMOLISH EXISITNG CEILING. PLYWOOD SHEATHING IS TO REMAIN
- W DEMOLISH OF GYPSUM BOARD TO STUDS
- X DEMOLISH EXISTING WINDOW, SILL AND TRIM- INFILL WITH WALL TYPE "B"

NIM ARCHITECTS
64S G STREET, SUITE 400 ANCHORAGE ,AK 99501 (907)-258-7777
PALMER 111WEST EVERGREEN AVE. PALMER,AK 99645 (907)-258-7777
CORPORATE NO. AECL1227. TITLE OF SHEET

SUB SHEET NO.

AD101

DESIGNED:

TECH REVIEW

CADD.

MCG


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# **DEMO FLOOR PLANS -**FIRST FLOOR

SEWARD VISITOR CENTER REHAB KENAI FJORDS NATIONAL PARK

186 80.040 PMIS/PKG NO. 184638 SHEET 7 of 73



# **DEMO PLAN GENERAL NOTES**

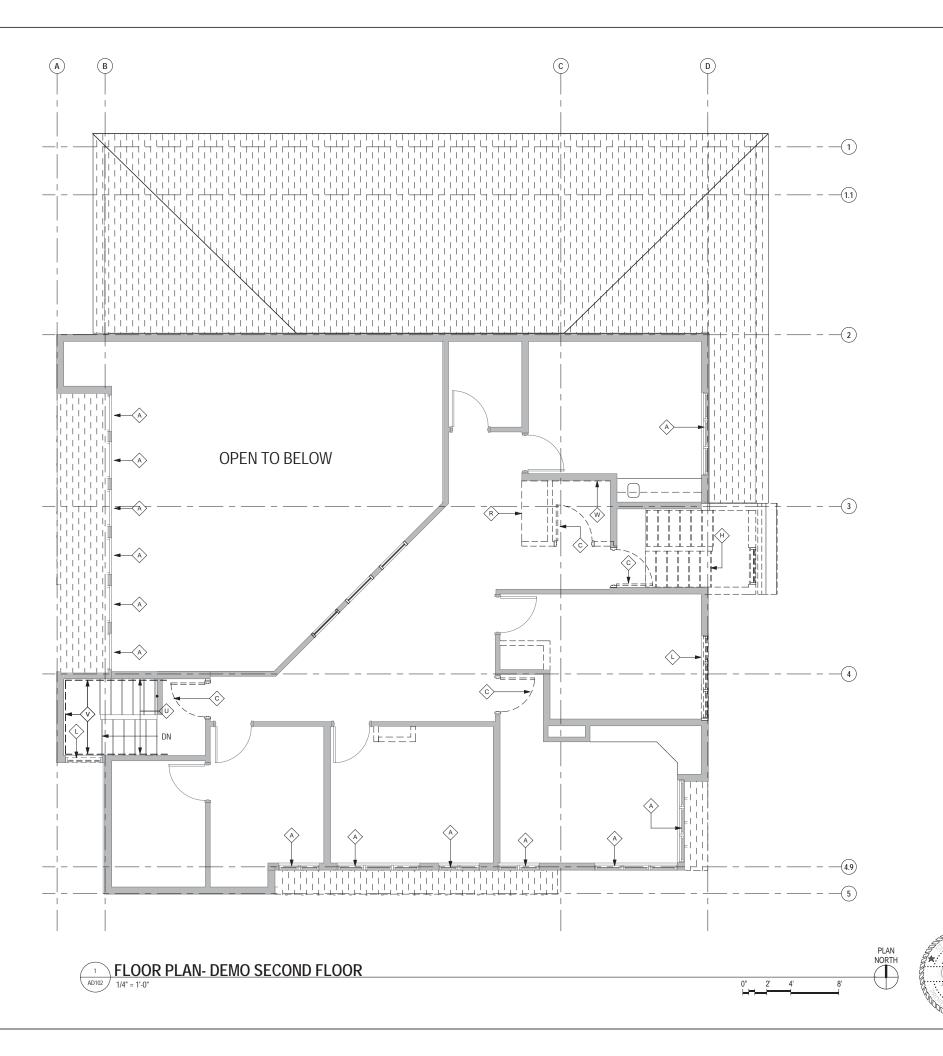- REFER TO SHEET G001 FOR GENERAL PROJECT NOTES
  REFER TO SHEET G002 AND G003 FOR CODE ANALYSIS AND ADDITIONAL LIFE SAFETY
- 3. DIMENSIONING GUIDE: ALL DIMENSIONS ARE TAKEN TO/FROM GRID LINE, FACE OF CONCRETE AND MASONRY, AND FACE OF METAL/WOOD STUD PARTITION, UNLESS OTHERWISE NOTED. CLEAR DIMENSIONS BETWEEN SURFACES WILL BE NOTED WHERE APPLICABLE FROM MATERIAL FINISHES. ALL DIMENSIONS REFERENCED HEREIN ARE IMPERIAL STANDARDS, UNLESS OTHERWISE NOTED. FOR THE PURPOSE OF THIS PROJECT, ALL DIMENSIONS HEREIN SHALL BE TREATED EQUALLY, WITHOUT ANY HIERARCHY, AND/OR ORDER OF PRECEDENCE, UNLESS OTHERWISE NOTED
- REFERENCE ELEVATION: ALL ELEVATIONS NOTED ON THIS PLAN CORRESPOND TO REFERENCE ELEVATION 0'-0" AS THE EXISTING FIRST FLOOR LEVEL, DEVIATIONS AND VARIANCES IN THIS ELEVATION MAY EXIST, AS INDICATED. UPPER FLOOR ELEVATIONS TO BE NOTED ACCORDINGLY. NOTE: THIS ASSISTS AND ESTABLISHES NOTED VERTICAL CONTROL AT ALL FLOOR PLANS, REGARDLESS TO FLOOR LEVEL.

  5. DOOR OPENINGS: ALL DOOR OPENINGS (INCLUDING DOOR, FRAME AND HARDWARE)
- THAT ARE BEING SHOWN AS DEMOLISHED ARE TO REUSED AND REINSTALLED AS SHOWN ON THE FLOOR PLAN- REFER TO SHEETS A101, A102, AND OPENING SCHEDULE ON SHFFT A601
- 6. ROOM FINISHES: ALL FLOOR FINISHES ARE TO BE DEMOLISHED, EXISTING FIRST FLOOR WALL BASE IS TO BE SALVAGED, PAINTED AND REINSTALLED. CONTRACTOR HAS THE OPTION TO LEAVE IN PLACE OR REMOVE AND REINSTALL- REFER TO SHEETS A103 AND A104 FOR NEW FINISHES.
- 7. REFLECTED CEILING PLAN: REFER TO SHEET A105 AND A106 FOR THE CORRESPONDING RCP FOR THIS AREA.
- 8. ALL EXTERIOR SIDING AND EXISTING WEATHER BARRIER TO BE REMOVED- EXISTING SHEATHING TO REMAIN.
- ALL ROOFING AND UNDERLAYMENTS TO BE REMOVED TO THE SHEATHING- EXISTING SUBSTRATE SHEATHING TO REMAIN.
- 10. THE GOVERNMENT WILL BE RESPONSIBLE FOR THE REMOVAL OF ALL STORED ITEMS IN CRAWL SPACE, ATTIC, AND ELSEWHERE, AS WELL AS ALL SHELVING AND FURNITURE ON THE PREMISES
- 11. ALL EXISTING COLUMNS IN DEMOLISHED WALLS TO REMAIN UNLESS NOTED OTHERWISE.
- 12. DEMOLISH ALL EXISTING CEILINGS ON FIRST FLOOR EXCEPT IN ROOM 112 SERAC STORAGE AND 101A MAIN EXHIBIT SPACE

### **DEMOLITION LEGEND**



EXISTING TO REMAIN



ITEMS TO BE DEMOLISHED- REFER TO SHEET NOTES FOR ADDITIONAL INFORMATION



EXISTING DOOR NUMBER FOR RELOCATION IDENTIFICATION- REFER TO DOOR SCHEDULE ON SHEET A602 FOR WHERE TO REINSTALL



ROOFING AND UNDERLAYMENTS TO BE DEMOLISHED- EXISITNG SHEATHING TO REMAIN

# **DEMOLITION SHEET NOTES**

SHOWN IN PLAN AS X

- EXISTING OPENING TO REMAIN- BID OPTION 1 TO REPLACE THESE OPENINGS WITH NEW
- EXISTING DOOR, FRAME AND HARDWARE TO BE REMOVED AND REINSTALLED
- C DOOR, DOOR FRAME AND HARDWARE TO BE DEMOLISHED
- DEMOLISH PORTION OF WALL TO CREATE NEW OPENING- REFER TO FLOOR PLANS FOR ADDITIONAL INFORMATION
- DEMOLISH FLOOR AND STRUCTURE BELOW- REFER TO STRUCTURAL DRAWINGS FOR ADDITIONAL INFORMATION
- REMOVE 4x12 DECK BOARDS TO INSTALL NEW SIDING. REINSTALL WHEN DECK BOARD SIDING WORK IS COMPLETED
- G EXISITNG SIDELIGHT TO BE REMOVED, SALVAGE FOR REINSTALLATION
- DEMOLISH STAIRS, FRAMING, HANDRAILS AND ACCESSORIES
- DEMOLISH DECK
- REMOVE WALL INFILL
- DEMOLISH EXISTING WINDOW, SILL AND TRIM- INFILL WITH WALL TYPE "2"
- DEMOLISH RAISED FLOOR AND STAIRS
- DEMOLISH CARPET OR WOOD PANELING PREPARE SURFACE TO RECIEVE NEW FINISH. REFER TO SHEETS A103&A104 FOR ADDITIONAL INFORMATION
- DEMOLISH COLUMN REFER TO STRUCTURAL DRAWINGS
- DEMOLISH BENCH
- EXISITING CASEWORK- TO BE REMOVED BY THE NATIONAL PARK SERVICE
- REMOVE WATER COOLER AND BOTTLE FILLER STATION, SALVAGE FOR REINSTALLATION IN NEW PLAN- REFER TO DETAIL 1/A401 FOR LOCATION
- EXISTING FLOOR ACCESS HATCH TO REMAIN REFER TO SHEET A101 FOR LOCATION
- DEMOLISH EXISTING HANDRAILS
- DEMOLISH GYPSUM BOARD WALLS OR TOP OF STRINGER TO UNDERSIDE OF STRUCTURE. DEMOLISH EXISITNG CEILING. PLYWOOD SHEATHING IS TO REMAIN
- W DEMOLISH OF GYPSUM BOARD TO STUDS
- X DEMOLISH EXISTING WINDOW, SILL AND TRIM- INFILL WITH WALL TYPE "B"

RIM ARCHITECTS 645 G STREET, SUITE 400 ANCHORAGE ,AK 99501 (907)-258-7777 PALMER 111WEST EVERGREEN AVE. PALMER,AK 99645 (907)-258-7777 CORPORATE NO. AECL1227.

TITLE OF SHEET DRAWING NO

**DEMO FLOOR PLANS -SECOND FLOOR** 


SEWARD VISITOR CENTER REHAB KENAI FJORDS NATIONAL PARK


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# FLOOR PLAN GENERAL NOTES

- REFER TO SHEET G001 FOR GENERAL PROJECT NOTES
   REFER TO SHEET G002 AND G003 FOR CODE ANALYSIS AND ADDITIONAL LIFE SAFETY GENERAL NOTES
- 3. DIMENSIONING GUIDE: ALL DIMENSIONS ARE TAKEN TO/FROM GRID LINE, FACE OF CONCRETE AND MASONRY, AND FACE OF METALWOOD STUD PARTITION, UNLESS OTHERWISE NOTED. CLEAR DIMENSIONS BETWEEN SURFACES WILL BE NOTED WHERE APPLICABLE FROM MATERIAL FINISHES. ALL DIMENSIONS REFERENCED HEREIN ARE IMPERIAL STANDARDS, UNLESS OTHERWISE NOTED. FOR THE PURPOSE OF THIS PROJECT, ALL DIMENSIONS HEREIN SHALL BE TREATED EQUALLY, WITHOUT ANY HIERARCHY, AND/OR ORDER OF PRECEDENCE, UNLESS OTHERWISE NOTED
- REFERENCE ELEVATION: ALL ELEVATIONS NOTED ON THIS PLAN CORRESPOND TO REFERENCE ELEVATION 0°-0° AS THE EXISTING FIRST FLOOR LEVEL. DEVIATIONS AND VARIANCES IN THIS ELEVATION MAY EXIST, AS INDICATED. UPPER FLOOR ELEVATIONS TO BE NOTED ACCORDINGLY. NOTE: THIS ASSISTS AND ESTABLISHES NOTED VERTICAL CONTROL AT ALL FLOOR PLANS, REGARDLESS TO FLOOR LEVEL.
- MOUNTING HEIGHTS: REFER TO SHEET G004 FOR TYPICAL MOUNTING HEIGHTS FOR FIXTURES. ACCESSORY ITEMS.AND MISCELLANEOUS DEVICES.
- ALL PENETRATIONS THROUGH INTERIOR PARTITIONS AND CEILING AROUND MECHANICAL 110 SHALL RECEIVE FIRESTOPPING.

# FLOOR PLAN LEGEND

EXISTING WALL CONSTRUCTION TO REMAIN

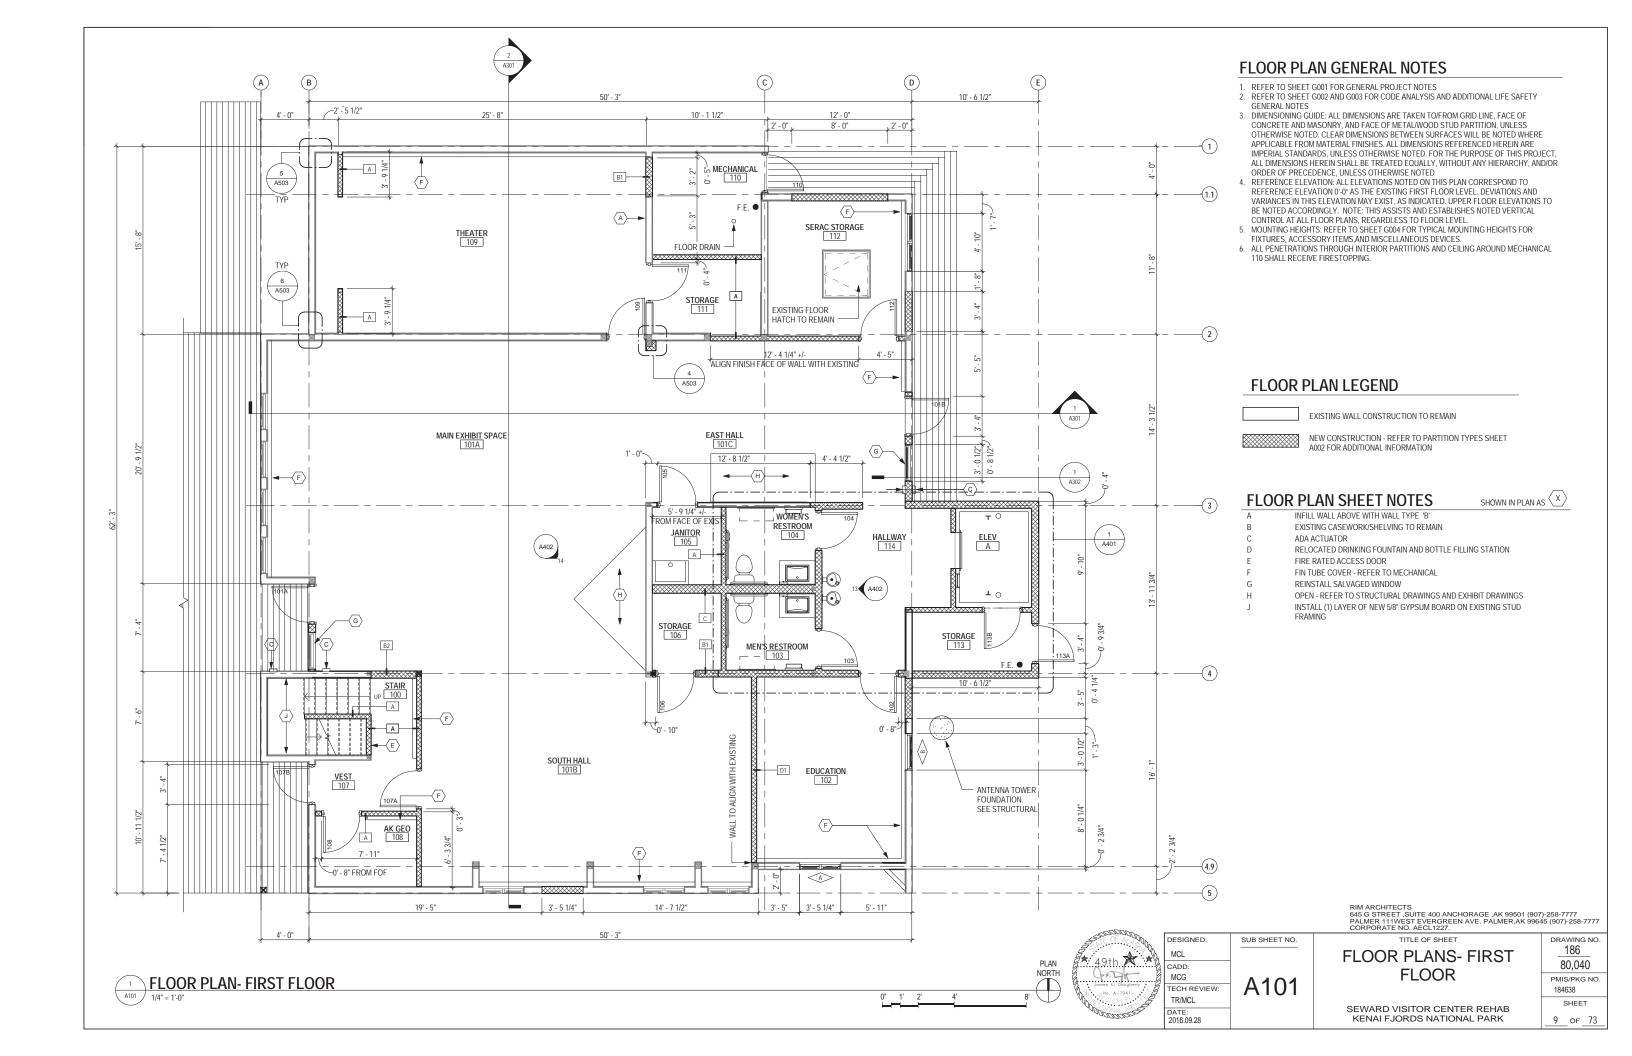NEW CONSTRUCTION - REFER TO PARTITION TYPES SHEET A002 FOR ADDITIONAL INFORMATION

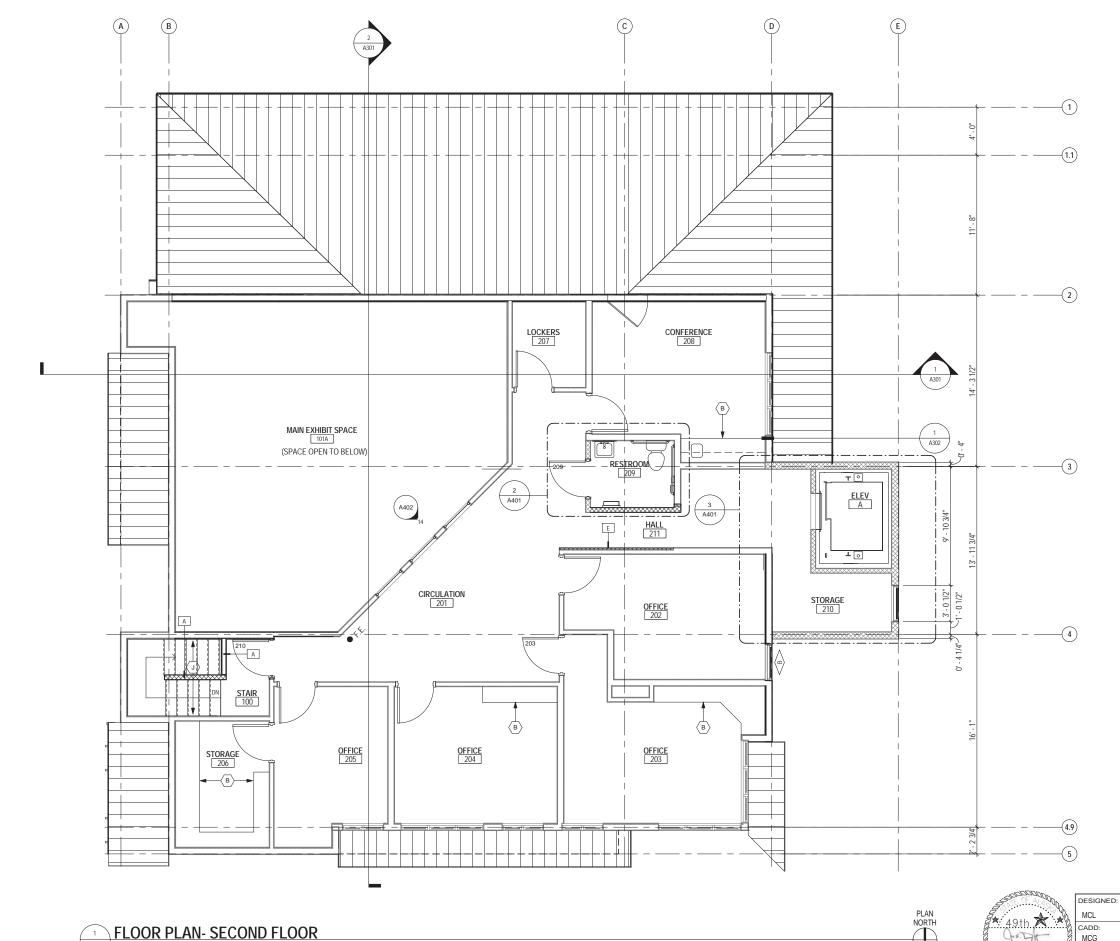FLOOR PLAN SHEET NOTES

 $\langle x \rangle$ SHOWN IN PLAN AS

- INFILL WALL ABOVE WITH WALL TYPE 'B'
- EXISTING CASEWORK/SHELVING TO REMAIN
- ADA ACTUATOR
- RELOCATED DRINKING FOUNTAIN AND BOTTLE FILLING STATION
- FIRE RATED ACCESS DOOR
- FIN TUBE COVER REFER TO MECHANICAL
- REINSTALL SALVAGED WINDOW
- OPEN REFER TO STRUCTURAL DRAWINGS AND EXHIBIT DRAWINGS
- INSTALL (1) LAYER OF NEW 5/8" GYPSUM BOARD ON EXISTING STUD

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SUB SHEET NO. MCG

TECH REVIEW:

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2016.09.28

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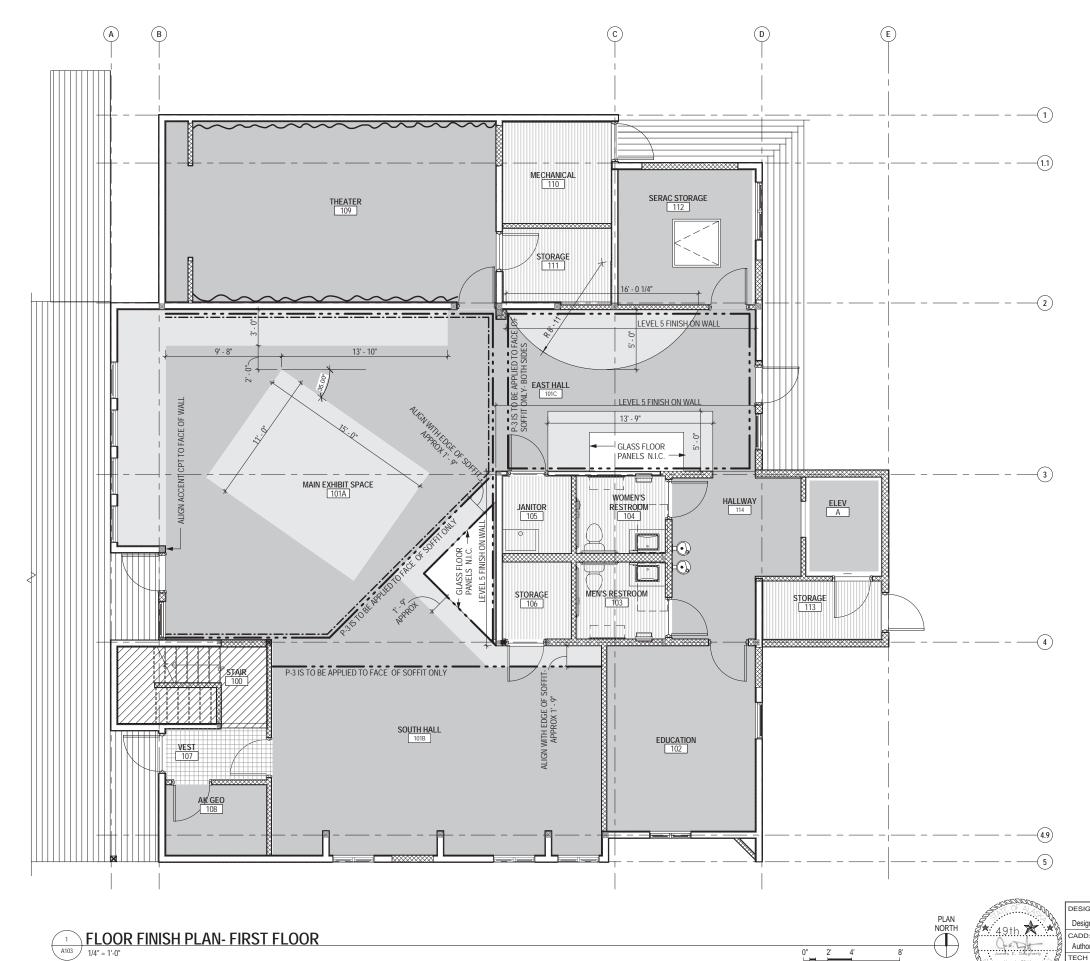
FLOOR PLANS- SECOND **FLOOR** 

SEWARD VISITOR CENTER REHAB KENAI FJORDS NATIONAL PARK

TITLE OF SHEET

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# FLOOR FINISH PLAN GENERAL NOTES

- 1. ALL INTERIOR WALLS TO RECEIVE PAINTED FINISH, UNO.
- ALL FLOORING TRANSITIONS OCCUR AT CENTERLINE OF DOOR OR OPENING, UNO.
   INDICATES WALLS THAT ARE NOT TO HAVE MECHANICAL OR ELECTRICAL DEVICES, I.E. THERMOSTATS, STROBES, EMERGENCY LIGHTS, ETC. DUE TO CONFLICT WITH SPECIAL FINISHES.
- 4. ALL FLOORS TO RECEIVE NEW FLOORING FINISH W/ NEW WALL BASE UNO.

# INTERIOR FINISH LEGEND

		CPT-1		SLIP RESISTANT RUBBER FLOORING					
		CPT-2		RESIL-1					
		CPT-3							
		RESILIENT TILE							
		EXISTING WALL CONS	TRUCTION TO	REMAIN					
			NEW CONSTRUCTION - REFER TO PARTITION TYPES SHEET A002 FOR ADDITIONAL INFORMATION						
$\overline{}$	$\sim$	WALL TO RECEIVE CAI PAINTED BLACK	RPET TO 4'-0" A	A.F.F W/ CHAIR RAIL -					
-		PAINT 1'-0" BAND ON W CEILING (FIELD VERIF		0" AFF TO 8'-0" AFF/UNDERSIDE OF					
_		PAINT WALL FROM GR CEILING BLACK, APPR		UNDER SIDE OF EXISTING -0"- P-3					

RIM ARCHITECTS 645 G STREET, SUITE 400 ANCHORAGE, AK 99501 (907)-258-7777 PALMER 111WEST EVERGREEN AVE. PALMER, AK 99645 (907)-258-7777 CORPORATE NO. AECL1227.



DESIGNED: SUB SHEET NO. Designer CADD: Author TECH REVIEW: TR/MCL 2016.09.28


A103


FLOOR FINISH PLAN -FIRST FLOOR

SEWARD VISITOR CENTER REHAB KENAI FJORDS NATIONAL PARK

TITLE OF SHEET

186 80,040 PMIS/PKG NO. 184638 SHEET 11 of 73

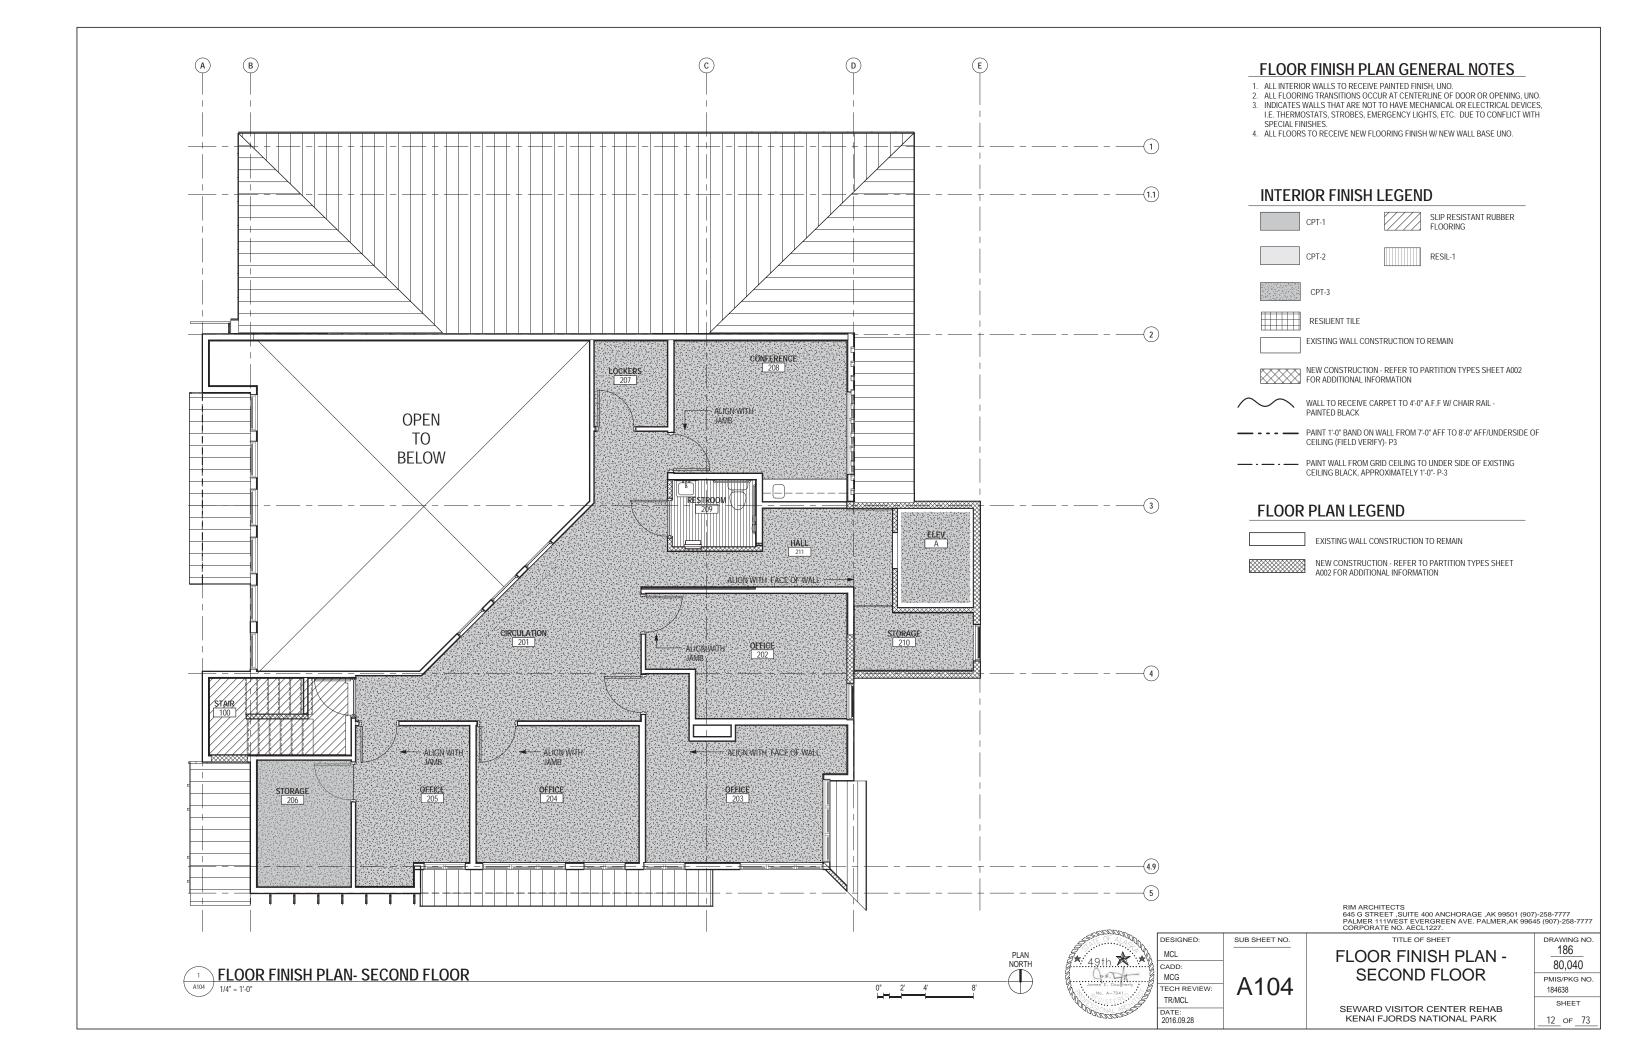

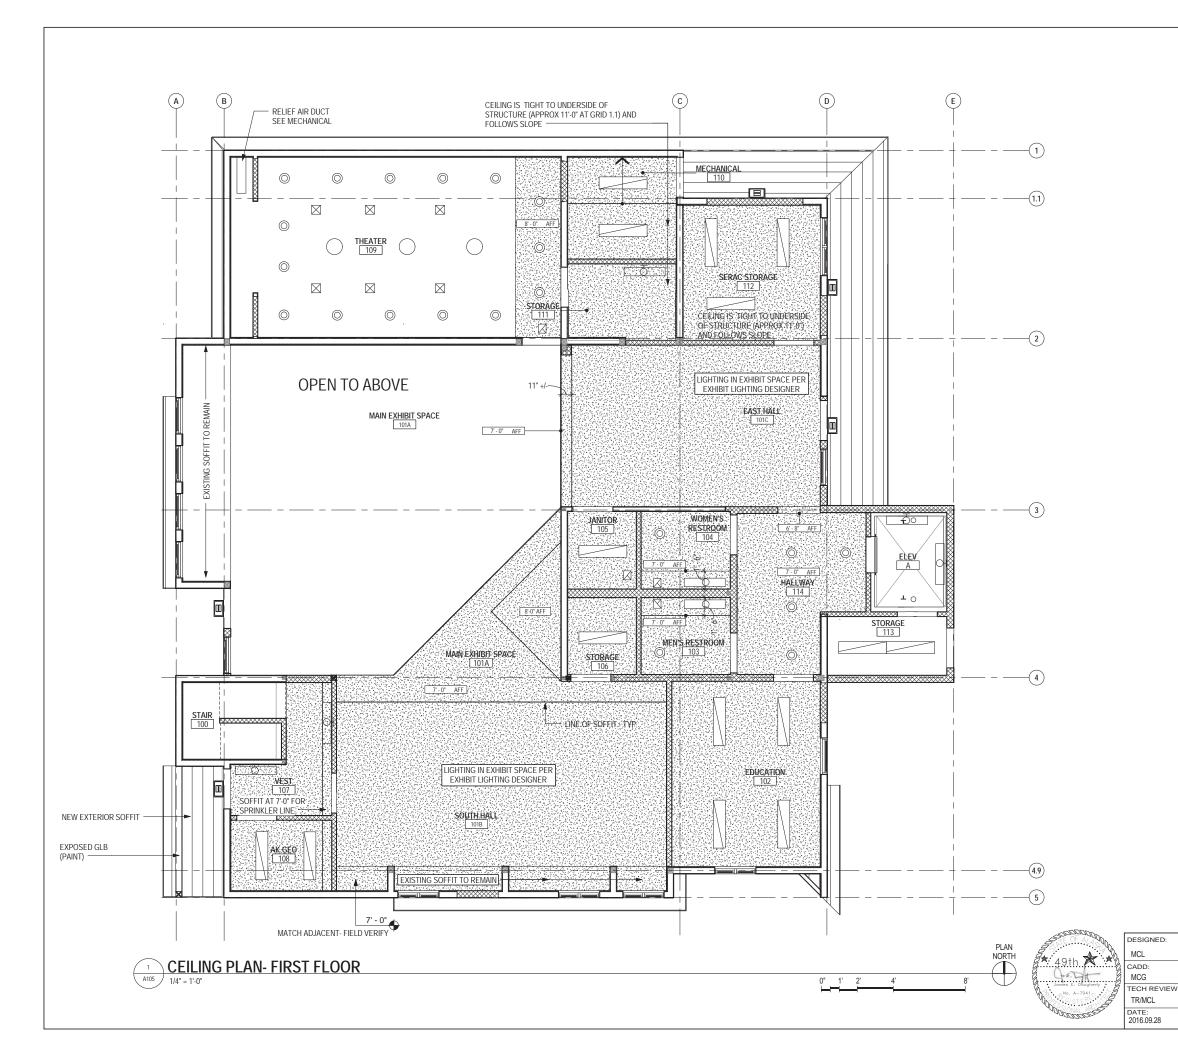


# **RCP GENERAL NOTES**

- 1. FIELD VERIFICATION: CONTRACTOR SHALL FIELD VERIFY ALL DIMENSIONS AND VERTICAL CONTROL PRIOR TO THE COMMENCEMENT OF WORK, PROMPTLY NOTIFY THE OWNER'S REPRESENTATIVE OR CONTRACTING OFFICER IN WRITING OF DISCREPANCIES IN NEW AND/OR EXISTING CONDITIONS. CONTRACTOR IS RESPONSIBLE FOR COORDINATION OF ALL ABOVE CEILING WORK TO ENSURE CLEARANCES FOR SCHEDULED CEILING HEIGHTS.
- 2. DIMENSION GUIDE: ALL DIMENSIONS ARE TAKEN TO/FROM GRID LINE, AND FACE OF WOOD STUD PARTITION, UNLESS OTHERWISE NOTED. CLEAR DIMENSIONS WILL BE NOTED WHERE APPLICABLE FROM MATERIAL FINISHES.
- 3. CEILING HEIGHTS: FIRST FLOOR: ALL CEILINGS DESIGNATED ON THIS PLAN SHALL BE INSTALLED ON THE UNDERSIDE OF EXISTING STRUCTURE (WHICH IS APPROXIMATELY 8'-0" A.F.F.), UNLESS OTHERWISE NOTED ON THE PLAN.
- SECOND FLOOR: ALL CEILINGS TO BE INSTALLED AT 8'-0" AND TO MATCH EXISITNG- FIELD VERIFY.

  ALL CEILING HEIGHTS CORRESPOND TO THE RESPECTIVE FINISH FLOOR
- ELEVATION/LEVEL.
- CEILING DEVICES: ALL CEILING LAYOUT PLANS SHOW MOST MAJOR
   MECHANICAL AND ELECTRICAL DEVICES. SEE MECHANICAL AND ELECTRICAL
   DOCUMENTS FOR ADDITIONAL M/E DEVICES INCLUDED IN THE CEILING CONFIGURATION. CONTRACTOR TO COORDINATE LAYOUT OF ALL DEVICES.
- 5. NEW EXTERIOR SOFFITS: ALL EXTERIOR SOFFITS TO COMPLY WITH DESIGN WIND PRESSURES FOR SPECIFIED LOADING REQUIREMENTS. SEE STRUCTURAL FOR PERFORMANCE REQUIREMENTS.
- LIGHTING IN EXHIBIT SPACE PER EXHIBIT LIGHTING DESIGNER.
- 7. SOFFIT UNDER EXISTING ROOF AT EAST PORCH TO REMAIN.
  8. SOFFIT UNDER EXISTING SOUTH AND WEST ROOF OVERHANGS TO REMAIN.
- 9. ALL NEW EXTERIOR SOFFITS TO BE 1 X 6 T&G LUMBER MATCH EXISTING

# RCP LEGEND

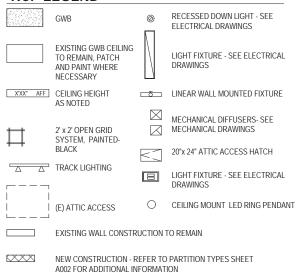

RIM ARCHITECTS 645 G STREET ,SUITE 400 ANCHORAGE ,AK 99501 (907)-258-7777 PALMER 111WEST EVERGREEN AVE. PALMER,AK 99645 (907)-258-7777 CORPORATE NO. AECL1227.


SUB SHEET NO. A105

REFLECTED CEILING PLAN - FIRST FLOOR

SEWARD VISITOR CENTER REHAB KENAI FJORDS NATIONAL PARK

TITLE OF SHEET

186 80.040 PMIS/PKG NO. 184638 SHEET 13 of 73

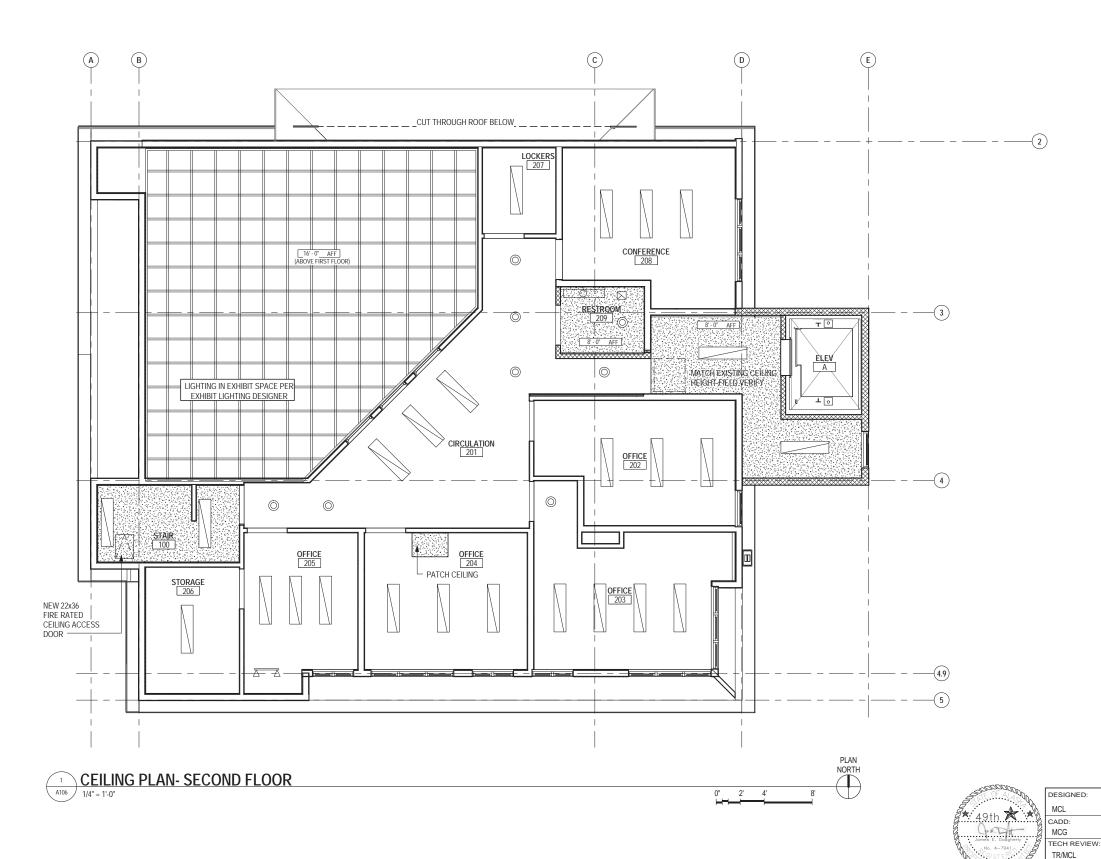

# **RCP GENERAL NOTES**

- 1. FIELD VERIFICATION: CONTRACTOR SHALL FIELD VERIFY ALL DIMENSIONS AND VERTICAL CONTROL PRIOR TO THE COMMENCEMENT OF WORK. PROMPTLY NOTIFY THE OWNER'S REPRESENTATIVE OR CONTRACTING OFFICER IN WRITING OF DISCREPANCIES IN NEW AND/OR EXISTING CONDITIONS. CONTRACTOR IS RESPONSIBLE FOR COORDINATION OF ALL ABOVE CEILING
- WORK TO ENSURE CLEARANCES FOR SCHEDULED CEILING HEIGHTS.

  2. DIMENSION GUIDE: ALL DIMENSIONS ARE TAKEN TO/FROM GRID LINE, AND FACE OF WOOD STUD PARTITION, UNLESS OTHERWISE NOTED. CLEAR DIMENSIONS WILL BE NOTED WHERE APPLICABLE FROM MATERIAL FINISHES.
- CEILING HEIGHTS:
   FIRST FLOOR: ALL CEILINGS DESIGNATED ON THIS PLAN SHALL BE INSTALLED
   ON THE UNDERSIDE OF EXISTING STRUCTURE (WHICH IS APPROXIMATELY 8'-0" A.F.F.), UNLESS OTHERWISE NOTED ON THE PLAN.
  SECOND FLOOR: ALL CEILINGS TO BE INSTALLED AT 8'-0" AND TO MATCH
  EXISITING- FIELD VERIFY.


- ALL CEILING HEIGHTS CORRESPOND TO THE RESPECTIVE FINISH FLOOR ELEVATION/LEVEL.
  4. CEILING DEVICES: ALL CEILING LAYOUT PLANS SHOW MOST MAJOR
- MECHANICAL AND ELECTRICAL DEVICES. SEE MECHANICAL AND ELECTRICAL DOCUMENTS FOR ADDITIONAL M/E DEVICES INCLUDED IN THE CEILING CONFIGURATION, CONTRACTOR TO COORDINATE LAYOUT OF ALL DEVICES.
- 5. NEW EXTERIOR SOFFITS: ALL EXTERIOR SOFFITS TO COMPLY WITH DESIGN WIND PRESSURES FOR SPECIFIED LOADING REQUIREMENTS. SEE STRUCTURAL FOR PERFORMANCE REQUIREMENTS.
- 6. LIGHTING IN EXHIBIT SPACE PER EXHIBIT LIGHTING DESIGNER.
- 7. SOFFIT UNDER EXISTING ROOF AT EAST PORCH TO REMAIN.
  8. SOFFIT UNDER EXISTING SOUTH AND WEST ROOF OVERHANGS TO REMAIN.
- 9. ALL NEW EXTERIOR SOFFITS TO BE 1 X 6 T&G LUMBER MATCH EXISTING

# RCP LEGEND

SUB SHEET NO.

A106

2016.09.28

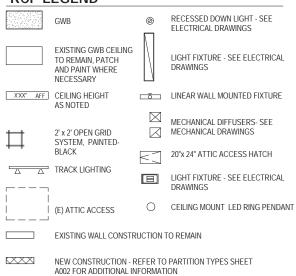

RIM ARCHITECTS 645 G STREET, SUITE 400 ANCHORAGE, AK 99501 (907)-258-7777 PALMER 111WEST EVERGREEN AVE. PALMER, AK 99645 (907)-258-7777 CORPORATE NO. AECL1227.

TITLE OF SHEET


REFLECTED CEILING PLAN - SECOND FLOOR

PMIS/PKG NO. 184638 SHEET 14 of 73

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80.040

SEWARD VISITOR CENTER REHAB KENAI FJORDS NATIONAL PARK

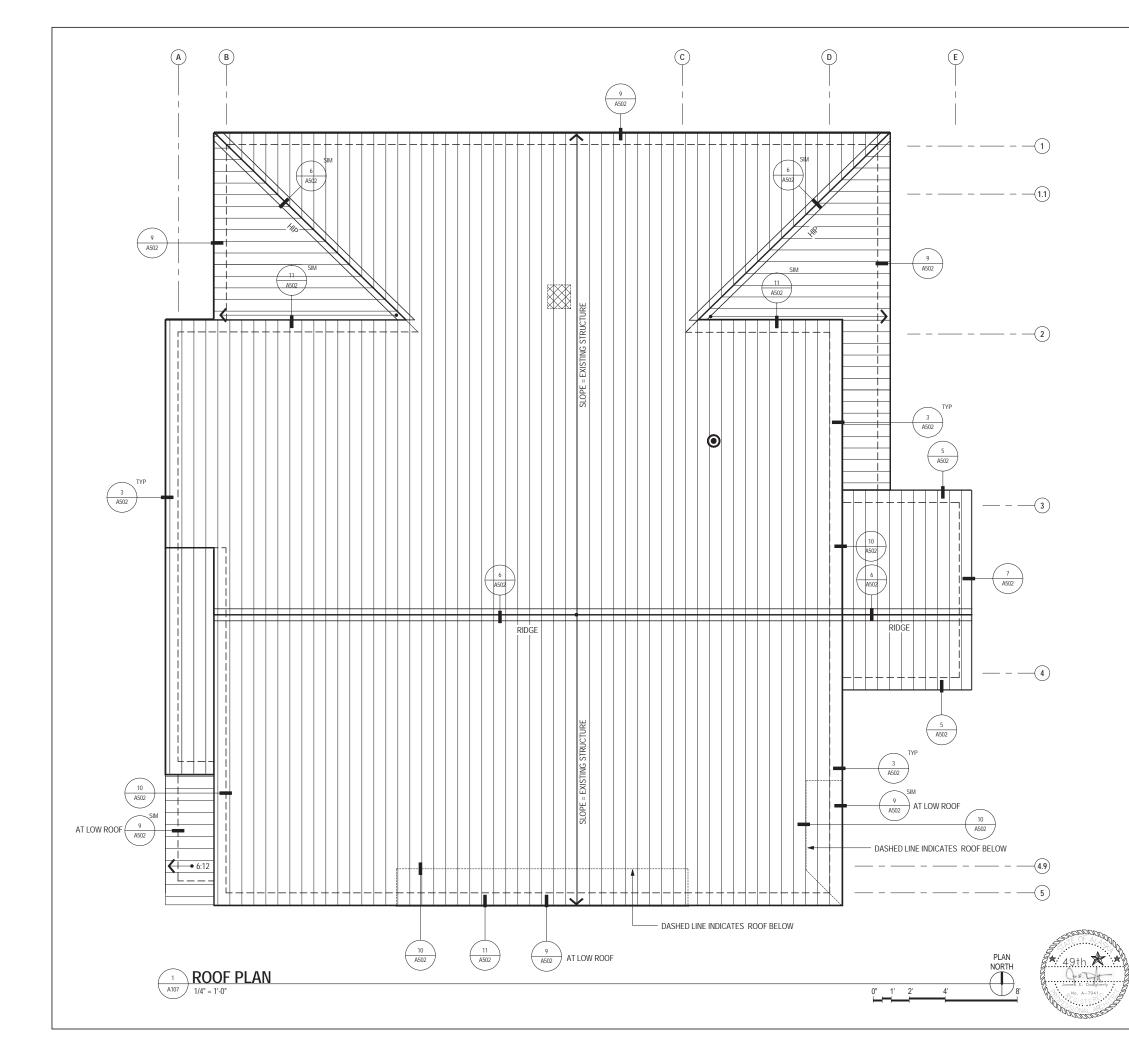

# **ROOF PLAN GENERAL NOTES**

- WIND LOADING: ALL EXTERIOR ROOFING ASSEMBLIES TO COMPLY WITH DESIGN WIND PRESSURES FOR SPECIFIED LOADING REQUIREMENTS, INCLUDING ALL RELATED METAL FLASHINGS. SEE STRUCTURAL FOR PERFORMANCE REQUIREMENTS.

  2. ALL ROOF PLANS SHOW MOST MAJOR MECHANICAL AND ELECTRICAL ROOF-
- MOUNTED EQUIPMENT AND DEVICES. SEE MECHANICAL AND ELECTRICAL DOCUMENTS FOR ADDITIONAL DEVICES INCLUDED ON THE ROOF. CONTRACTOR TO COORDINATE LAYOUTS AND MOUNTING REQUIREMENTS
- 3. ROOF SLOPE: NEW ROOF ASSEMBLY TO BE INSTALLED WITH EXISTING ROOF SLOPE. REMOVE AND REPALCE ALL EXISTING STANDING SEAM ROOFING, UNDERLAYMENT, TRIM & MISC. ACCESORIES. REFER TO DETAILS ON SHEET

# **ROOF PLAN LEGEND**

3" VTR - REFER TO DETAIL 1/A502



PATCH PLYWOOD FROM EXHAUST PENETRATION- PRIOR TO REROOFING



STANDING SEAM METAL ROOFING - REFER TO ASSEMBLY TYPES ON SHEET A303

RIM ARCHITECTS 645 G STREET, SUITE 400 ANCHORAGE, AK 99501 (907)-258-7777 PALMER 111WEST EVERGREEN AVE. PALMER, AK 99645 (907)-258-7777 CORPORATE NO. AECL1227.

DESIGNED: SUB SHEET NO. MCL CADD: MCG A107 TECH REVIEW: TR/MCL

2016.09.28


**ROOF PLAN** 


PMIS/PKG NO. 184638 SHEET 15 of 73


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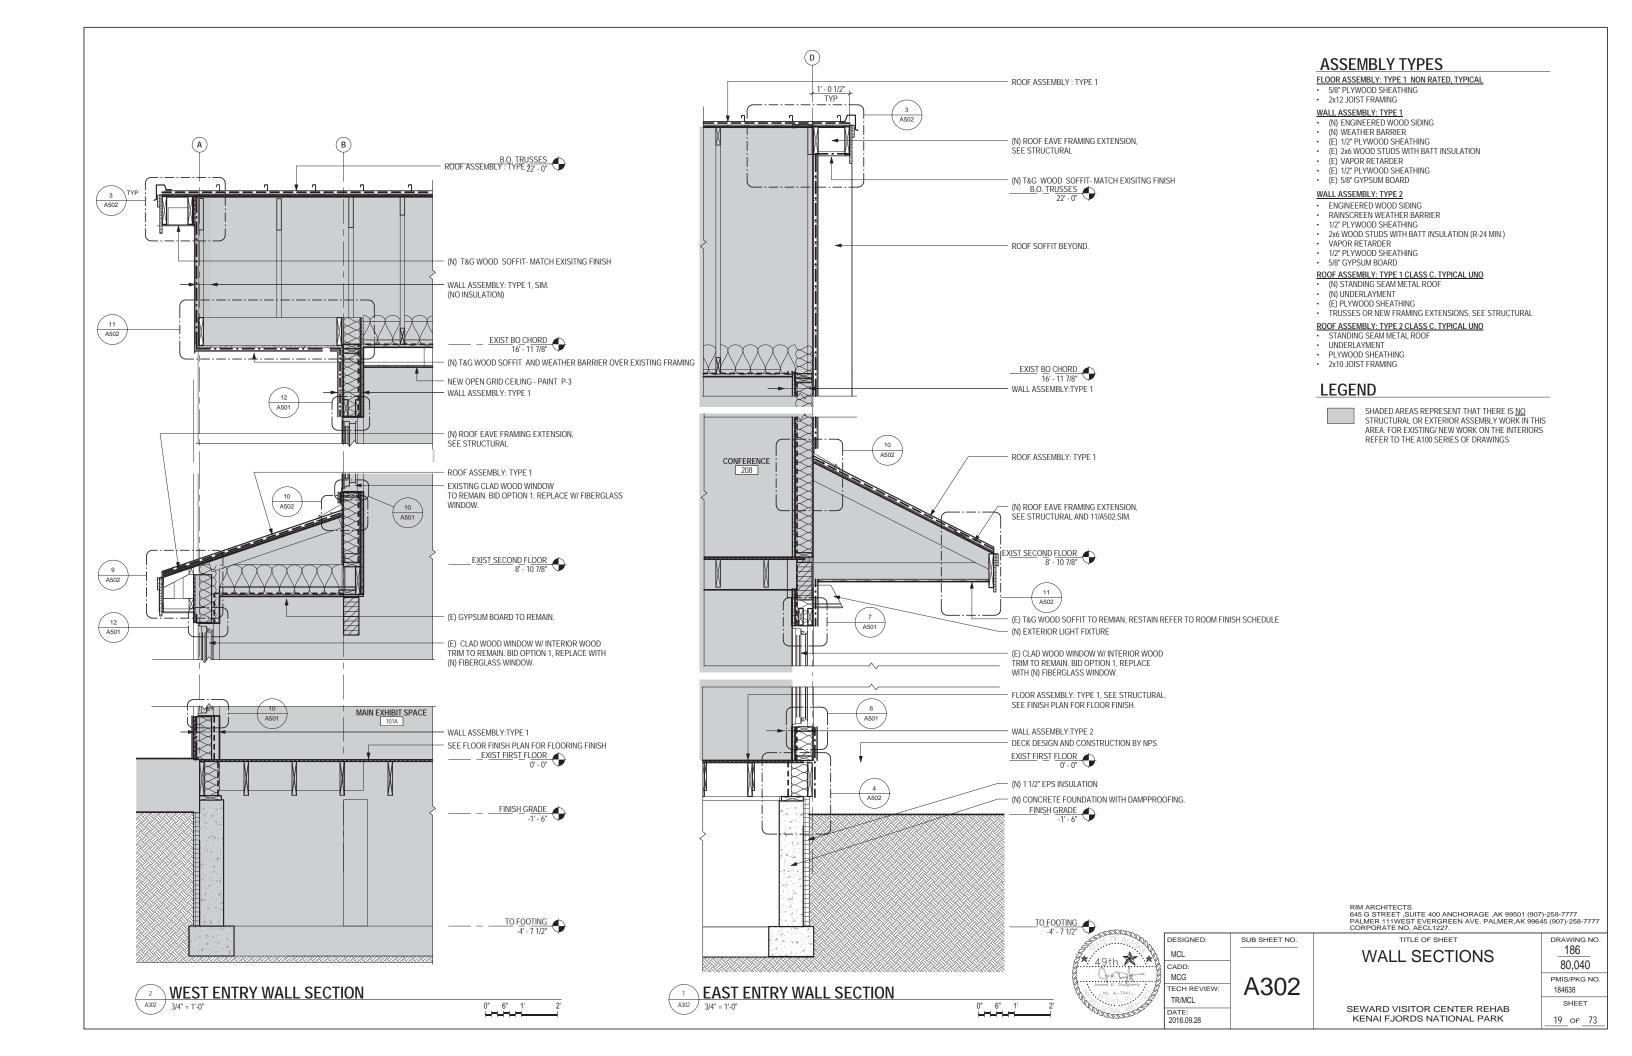
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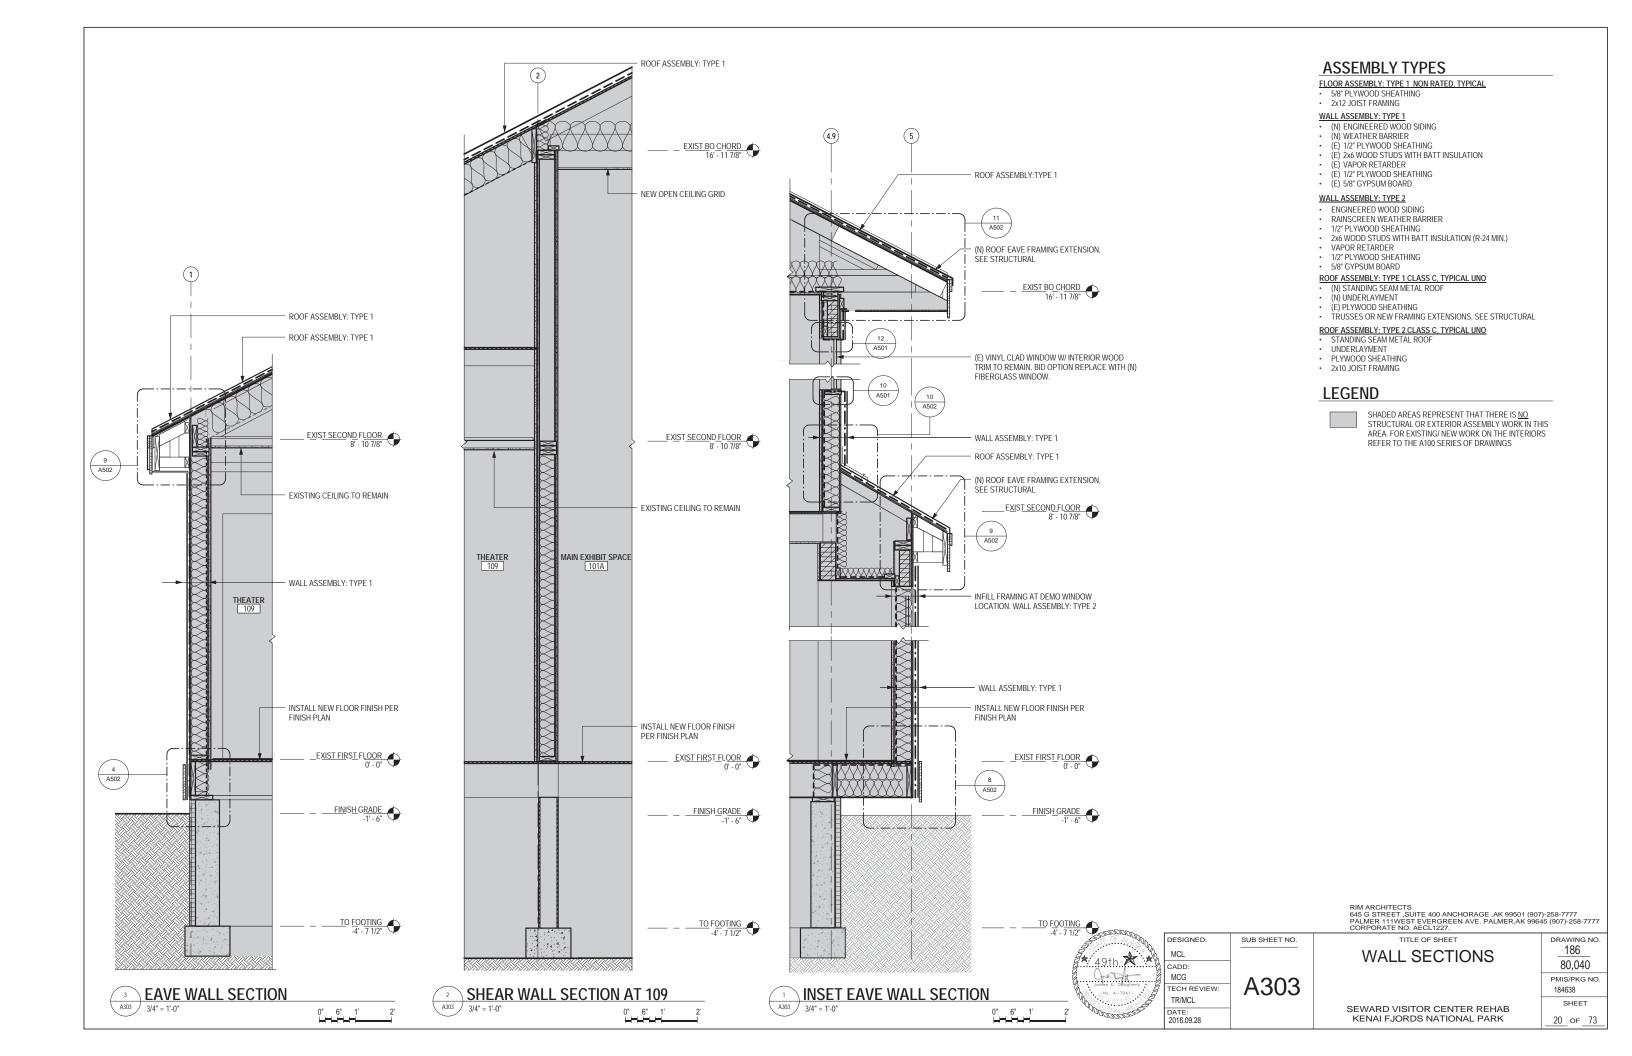
SEWARD VISITOR CENTER REHAB KENAI FJORDS NATIONAL PARK







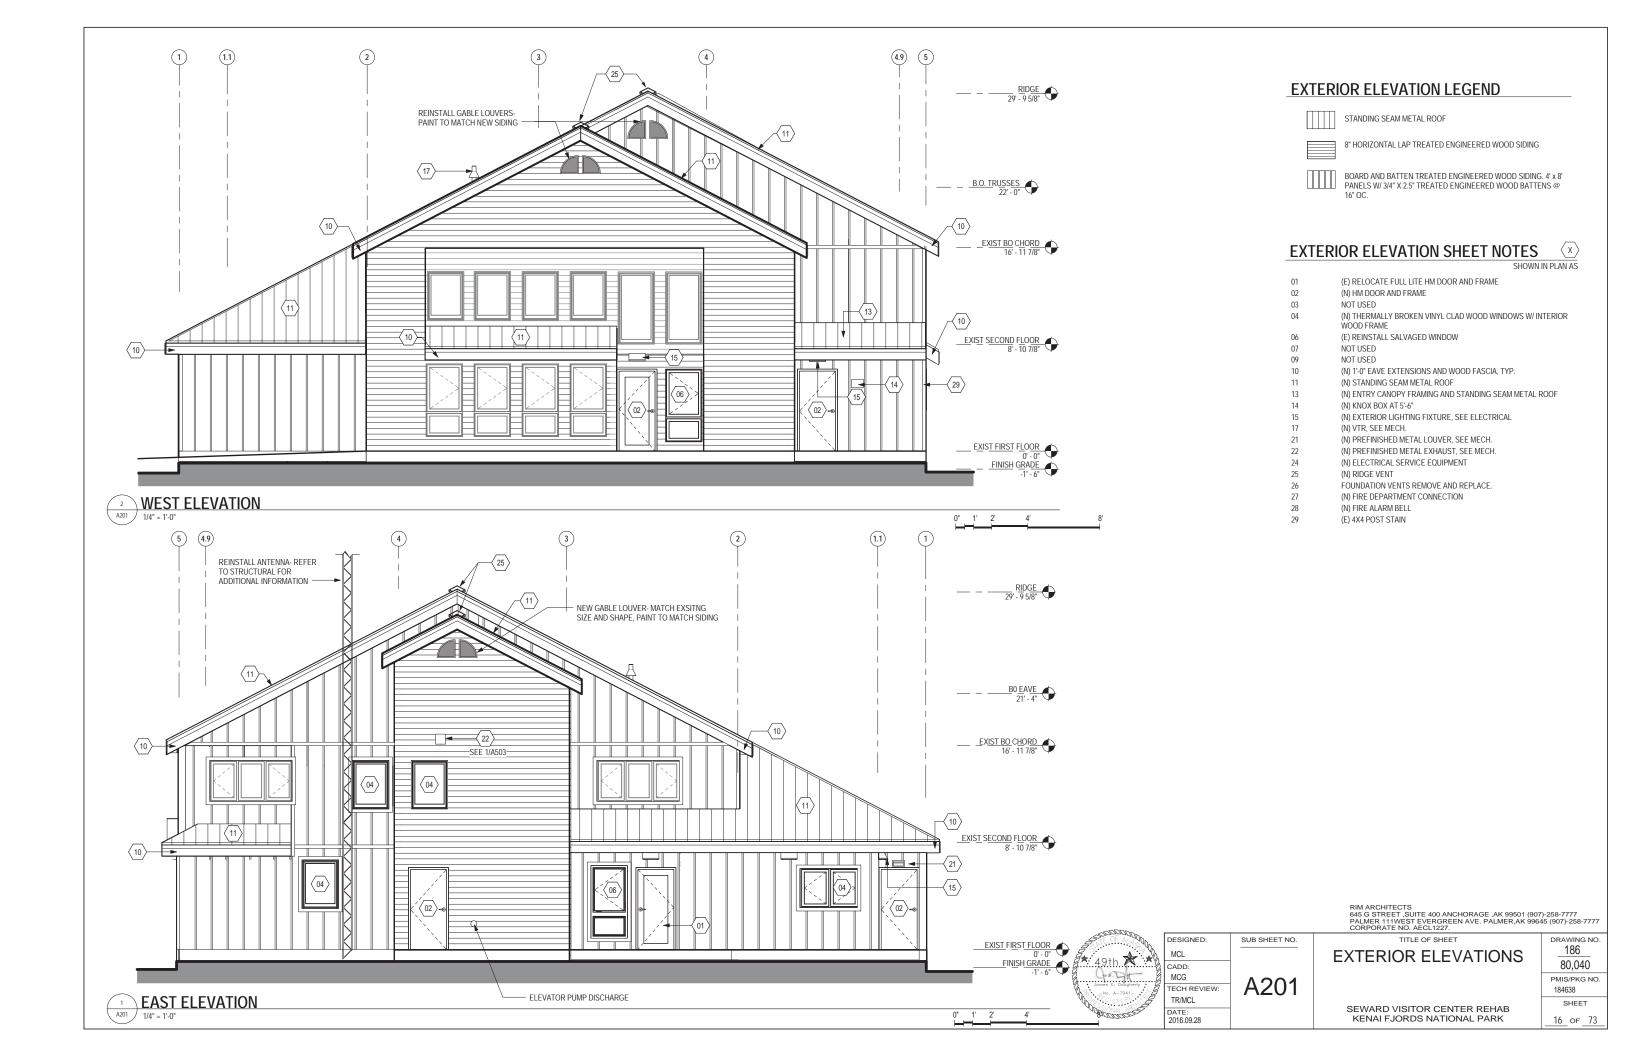

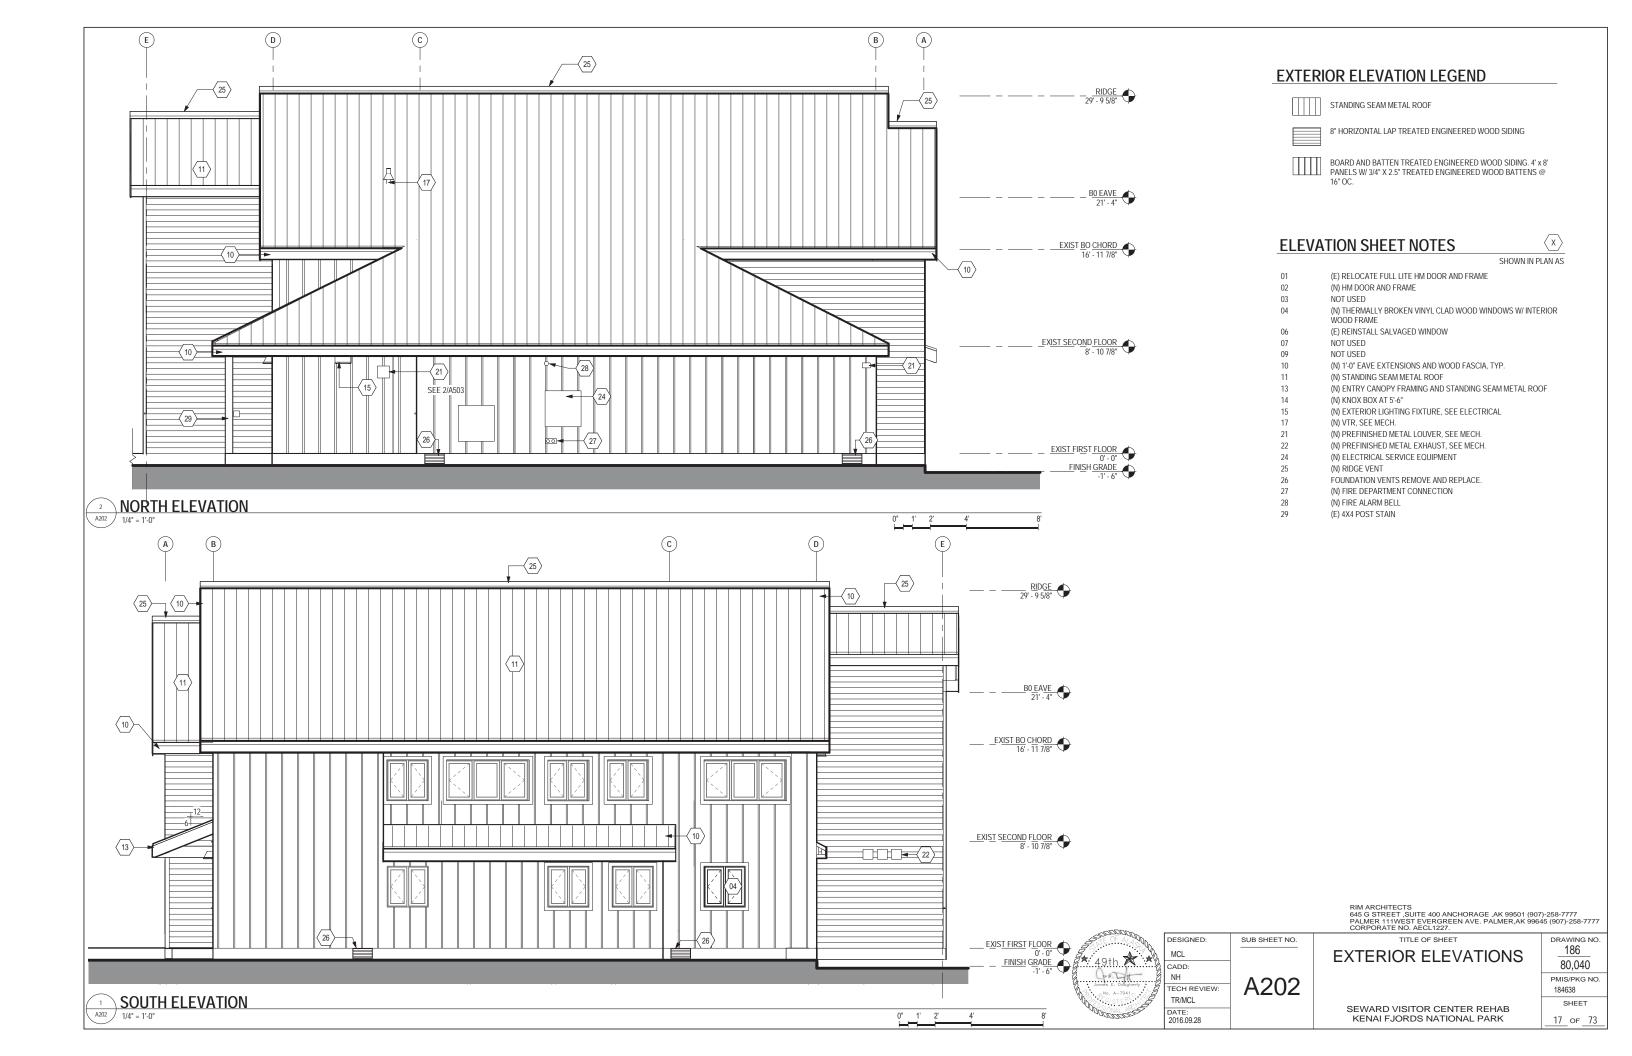

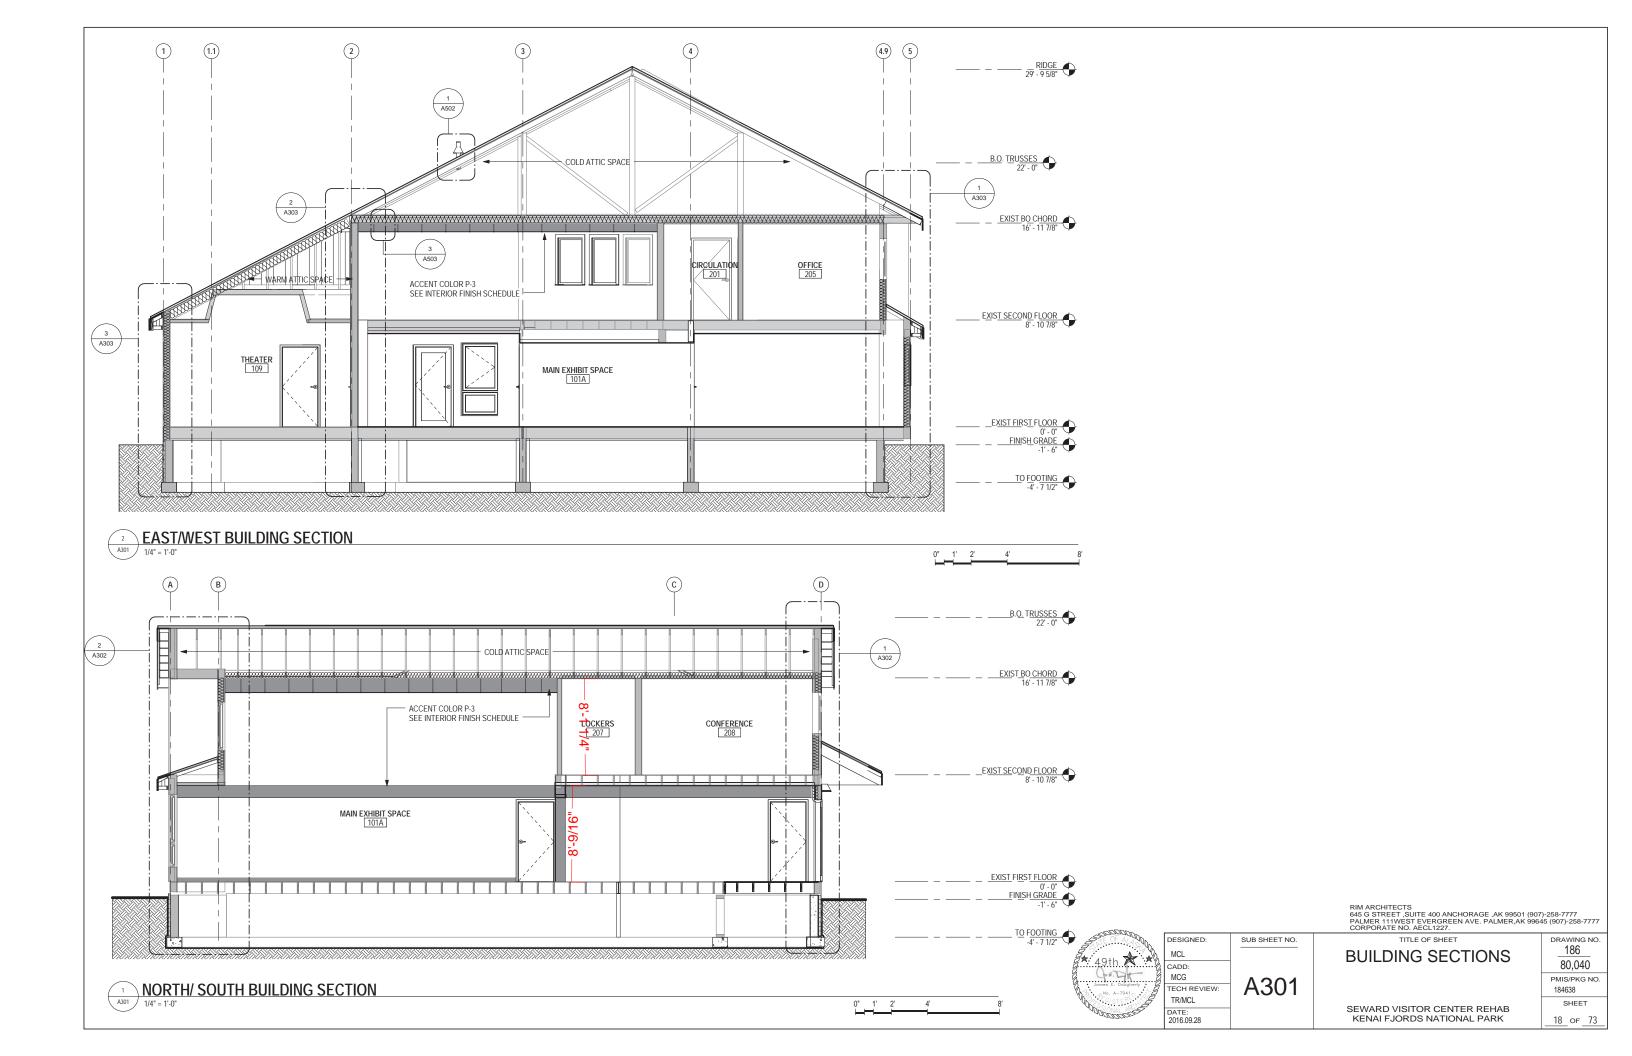

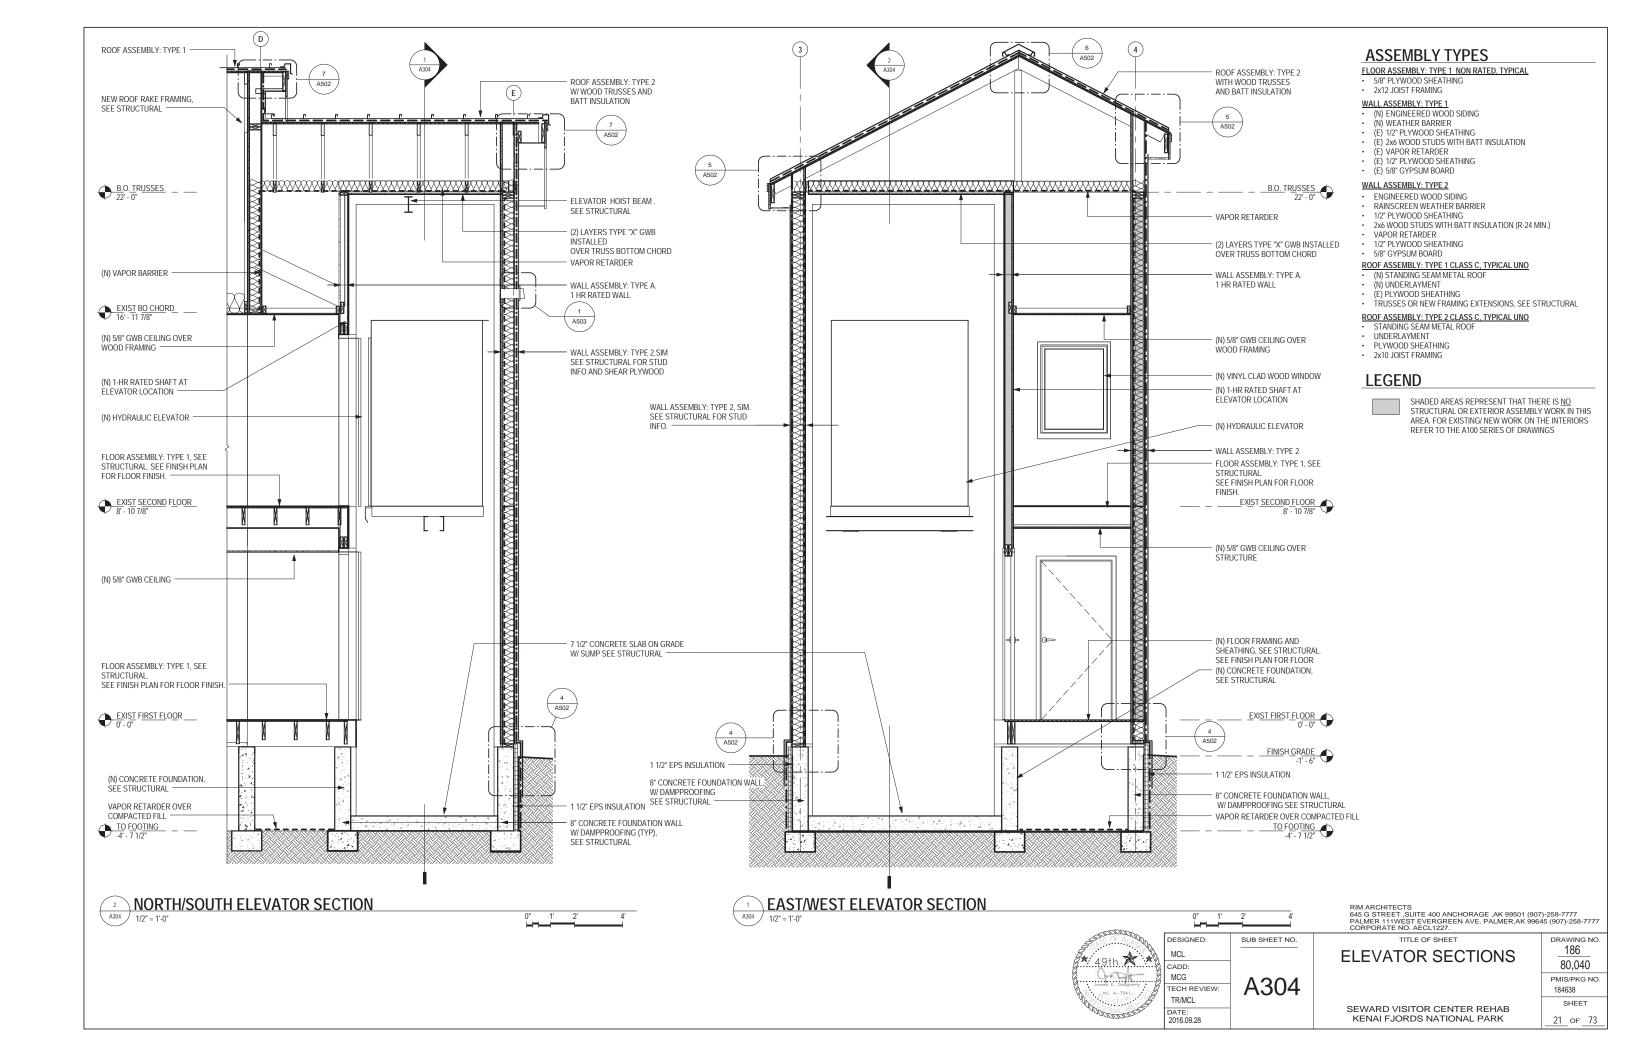

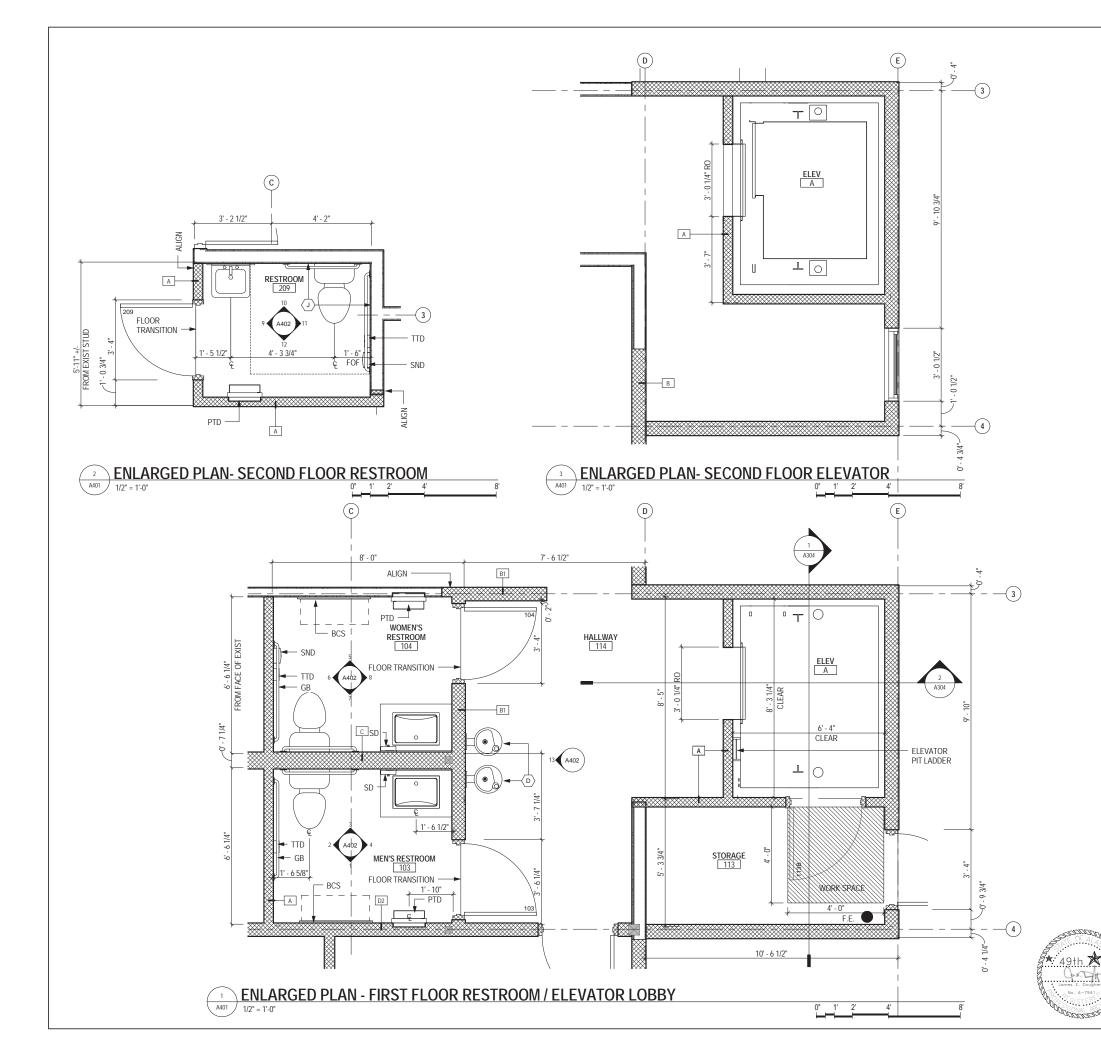

# FLOOR PLAN GENERAL NOTES

- REFER TO SHEET G001 FOR GENERAL PROJECT NOTES
   REFER TO SHEET G002 AND G003 FOR CODE ANALYSIS AND ADDITIONAL LIFE SAFETY GENERAL NOTES
- 3. DIMENSIONING GUIDE: ALL DIMENSIONS ARE TAKEN TO/FROM GRID LINE, FACE OF CONCRETE AND MASONRY, AND FACE OF METAL/WOOD STUD PARTITION, UNLESS OTHERWISE NOTED. CLEAR DIMENSIONS BETWEEN SURFACES WILL BE NOTED WHERE APPLICABLE FROM MATERIAL FINISHES. ALL DIMENSIONS REFERENCED HEREIN ARE IMPERIAL STANDARDS, UNLESS OTHERWISE NOTED. FOR THE PURPOSE OF THIS PROJECT, ALL DIMENSIONS HEREIN SHALL BE TREATED EQUALLY, WITHOUT ANY HIERARCHY, AND/OR ORDER OF PRECEDENCE, UNLESS OTHERWISE NOTED
- 4. REFERENCE ELEVATION: ALL ELEVATIONS NOTED ON THIS PLAN CORRESPOND TO REFERENCE ELEVATION 0'-0" AS THE EXISTING FIRST FLOOR LEVEL. DEVIATIONS AND VARIANCES IN THIS ELEVATION MAY EXIST. AS INDICATED, UPPER FLOOR ELEVATIONS TO BE NOTED ACCORDINGLY. NOTE: THIS ASSISTS AND ESTABLISHES NOTED VERTICAL
- CONTROL AT ALL FLOOR PLANS, REGARDLESS TO FLOOR LEVEL.

  5. MOUNTING HEIGHTS: REFER TO SHEET G004 FOR TYPICAL MOUNTING HEIGHTS FOR FIXTURES, ACCESSORY ITEMS, AND MISCELLANEOUS DEVICES.
- 6. ALL PENETRATIONS THROUGH INTERIOR PARTITIONS AND CEILING AROUND MECHANICAL 110 SHALL RECEIVE FIRESTOPPING.

# FLOOR PLAN LEGEND

EXISTING WALL CONSTRUCTION TO REMAIN NEW CONSTRUCTION - REFER TO PARTITION TYPES SHEET A002 FOR ADDITIONAL INFORMATION

# FLOOR PLAN SHEET NOTES

SHOWN IN PLAN AS  $\langle X \rangle$ 

- INFILL WALL ABOVE WITH WALL TYPE 'B'
- EXISTING CASEWORK/SHELVING TO REMAIN
- ADA ACTUATOR
- RELOCATED DRINKING FOUNTAIN AND BOTTLE FILLING STATION
- FIRE RATED ACCESS DOOR
- FIN TUBE COVER REFER TO MECHANICAL
- REINSTALL SALVAGED WINDOW
- OPEN REFER TO STRUCTURAL DRAWINGS AND EXHIBIT DRAWINGS
- INSTALL (1) LAYER OF NEW 5/8" GYPSUM BOARD ON EXISTING STUD

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DESIGNED: SUB SHEET NO. CADD: MCG A401 TECH REVIEW TR/MCL

DATE: 2016.09.28


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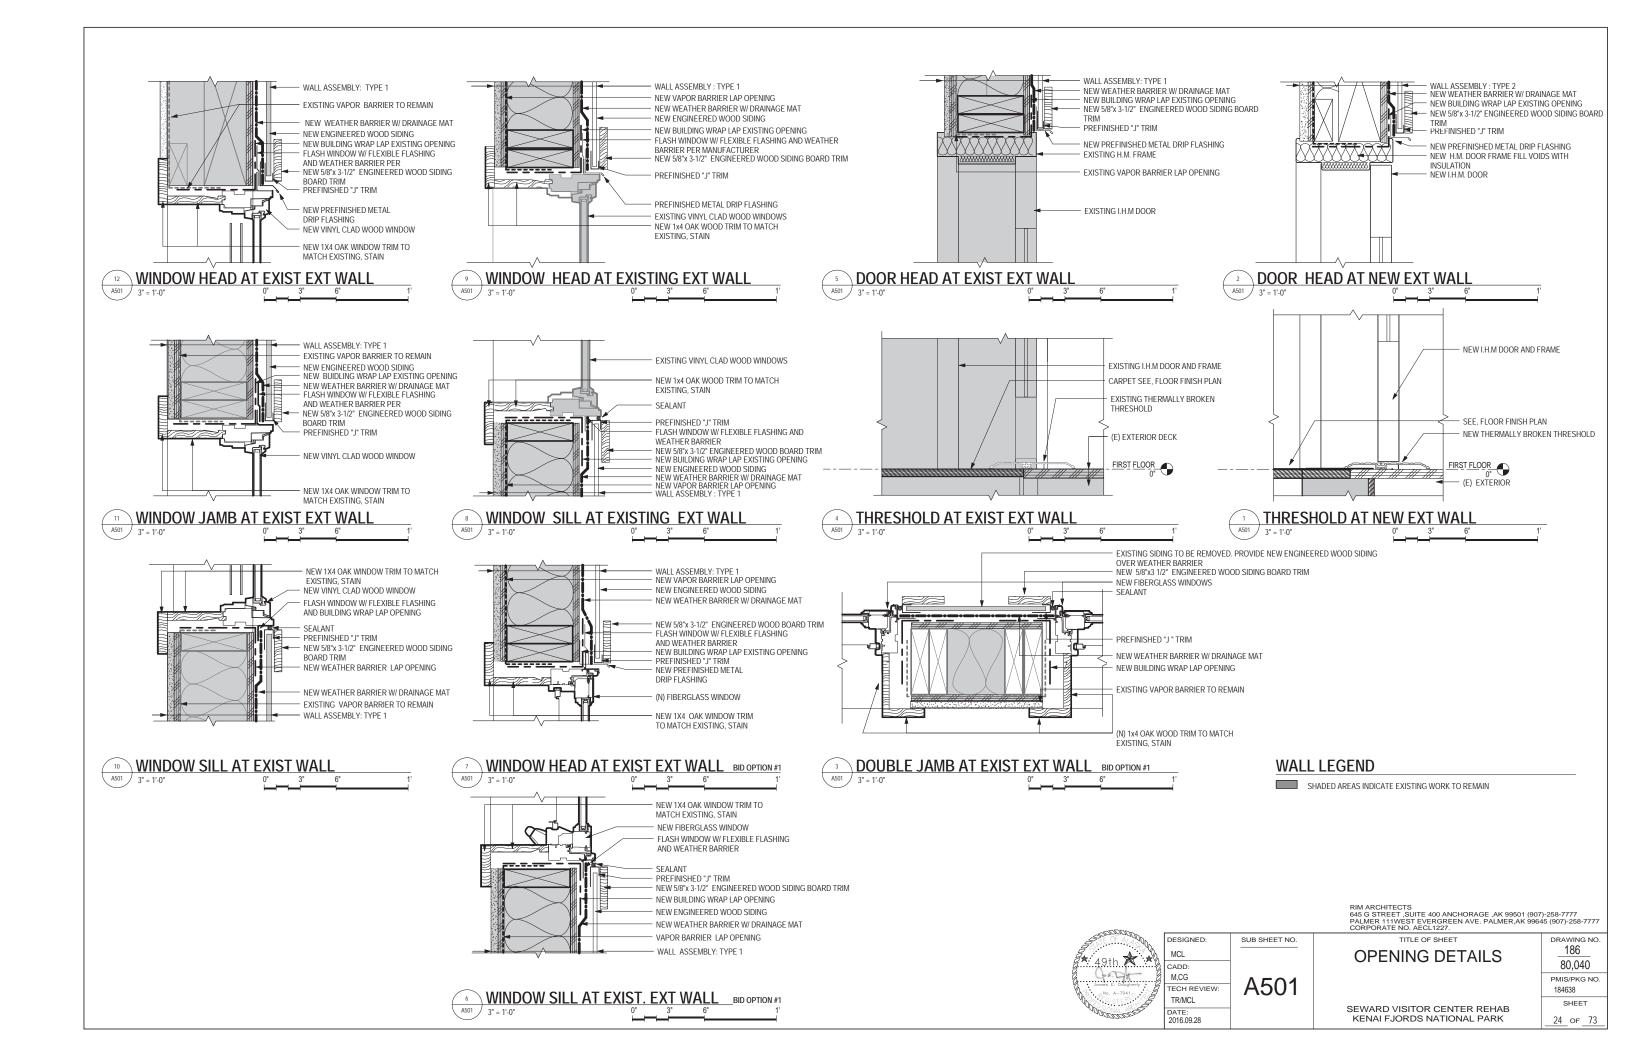
80.040 PMIS/PKG NO. 184638 SHEET


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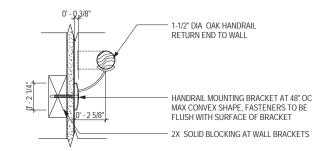
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SEWARD VISITOR CENTER REHAB KENAI FJORDS NATIONAL PARK









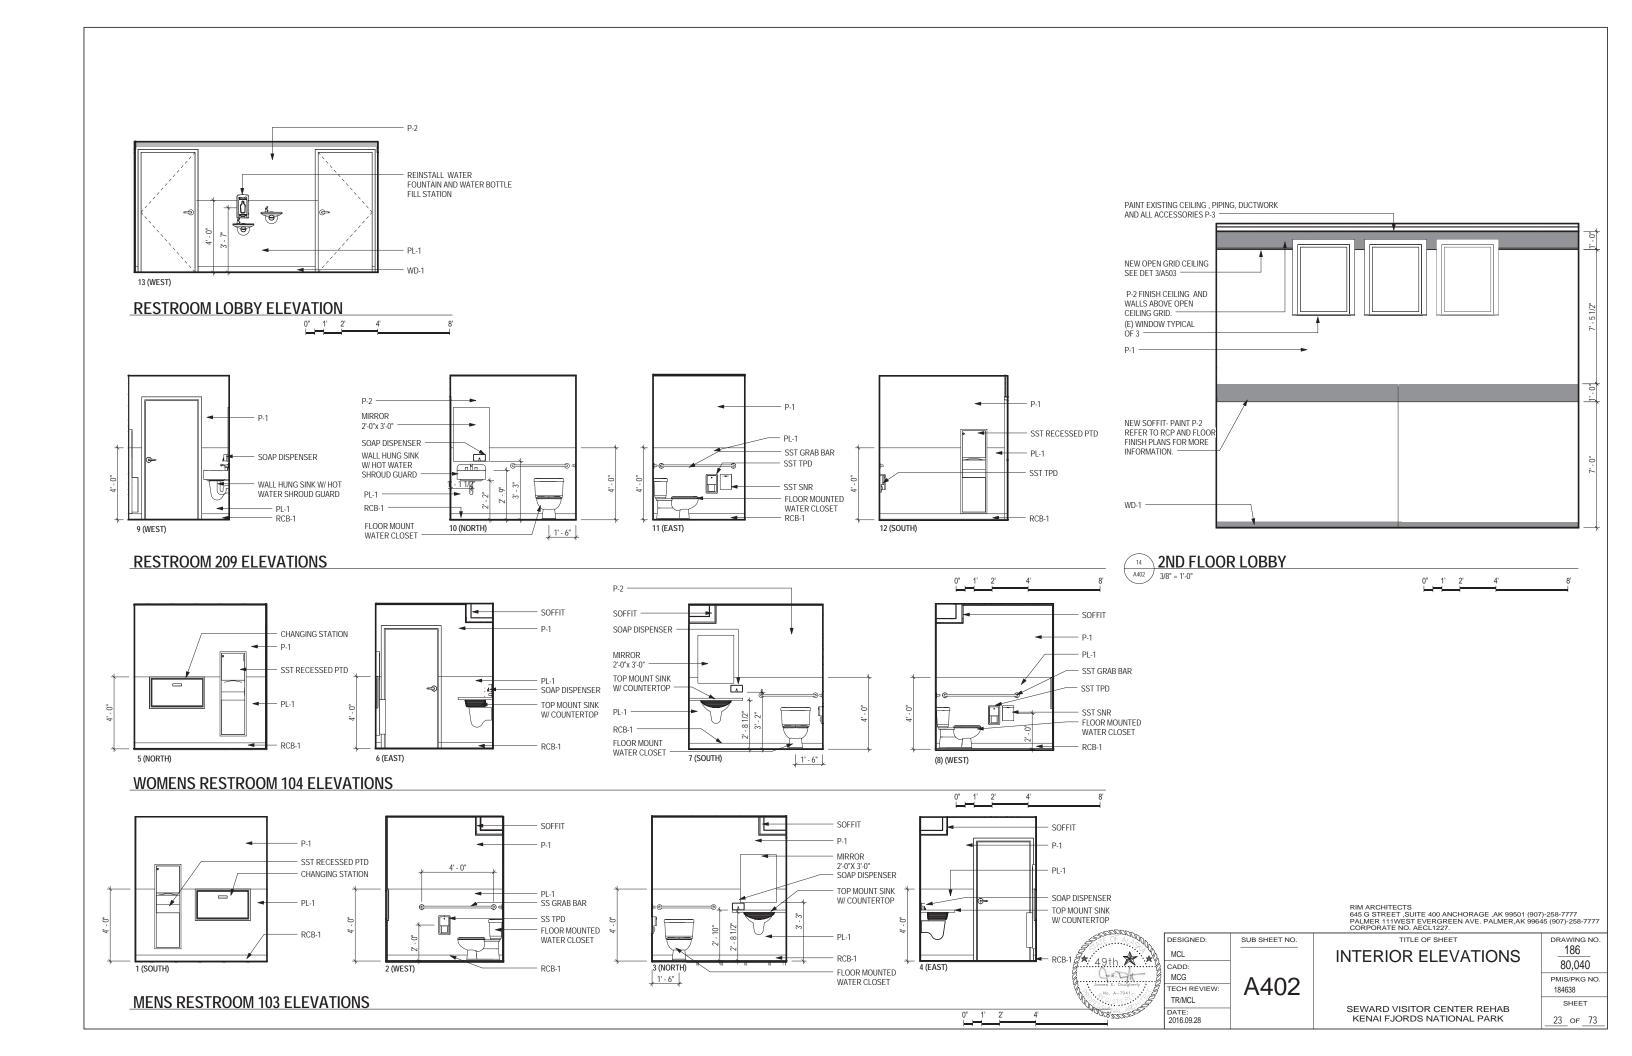


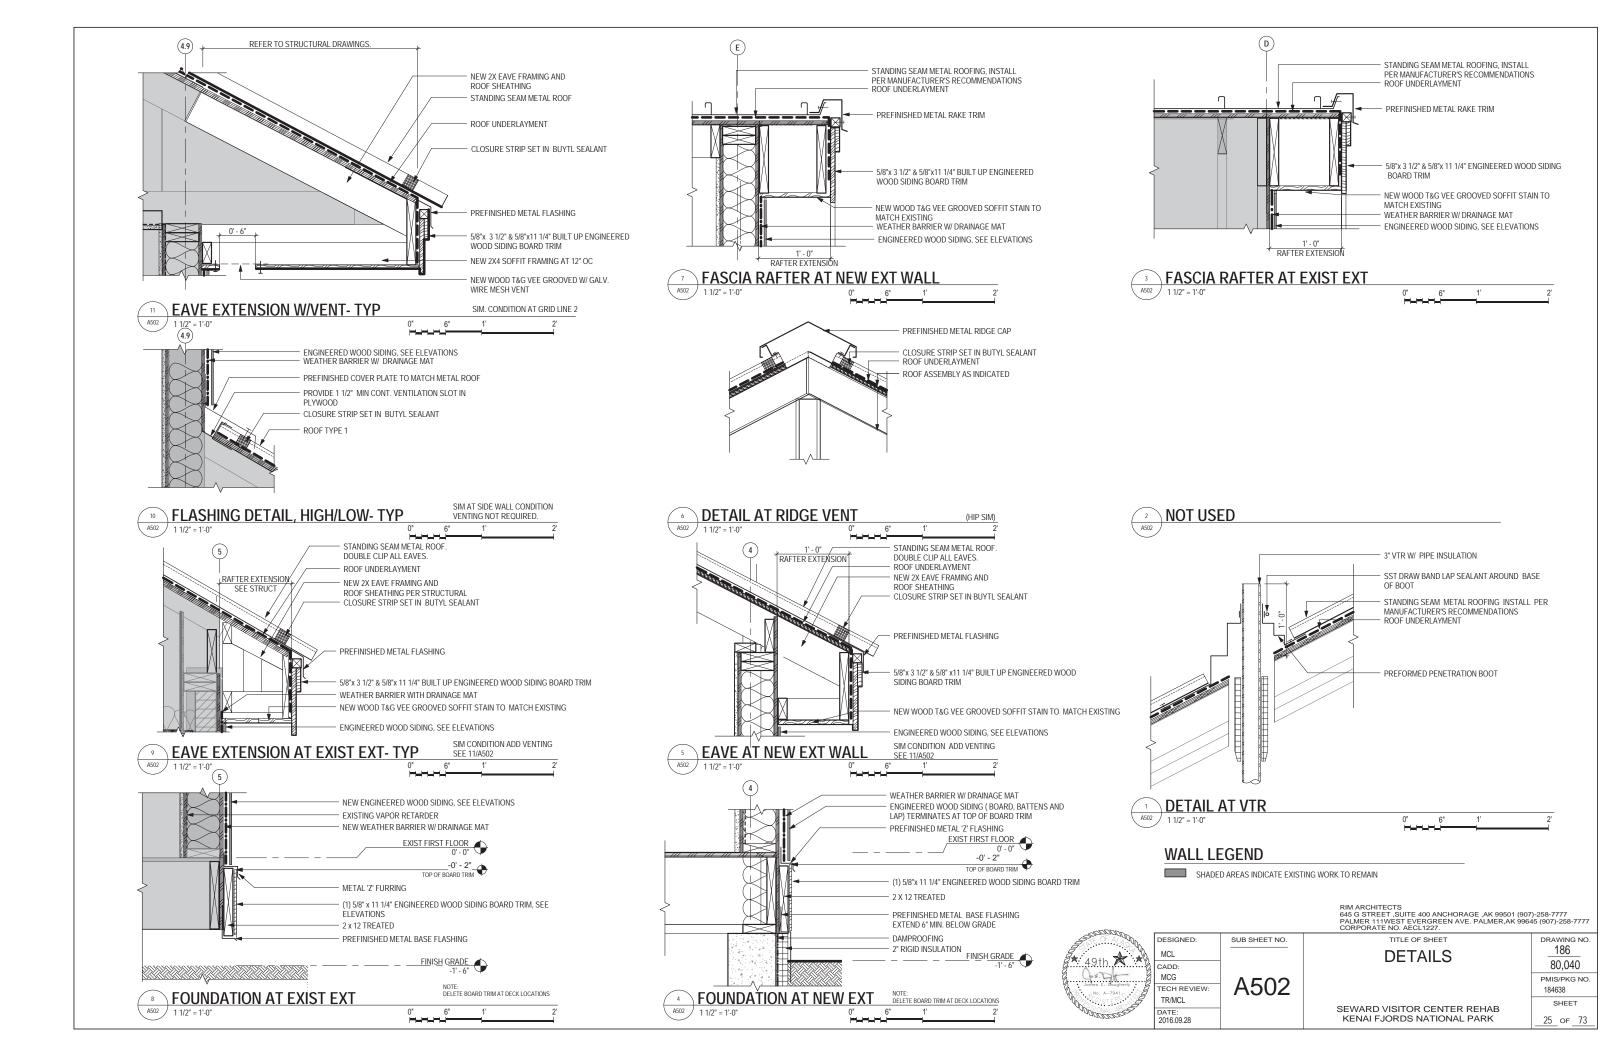


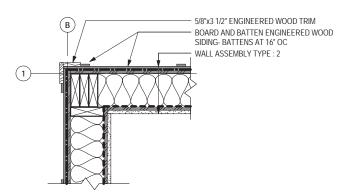




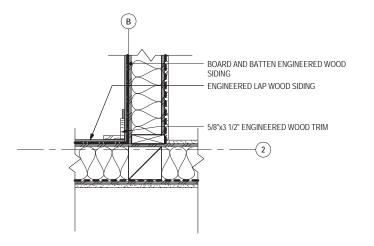


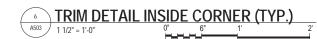


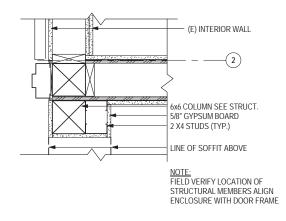



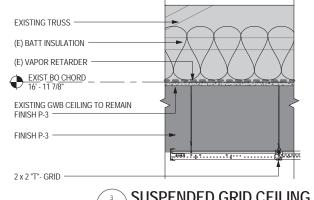

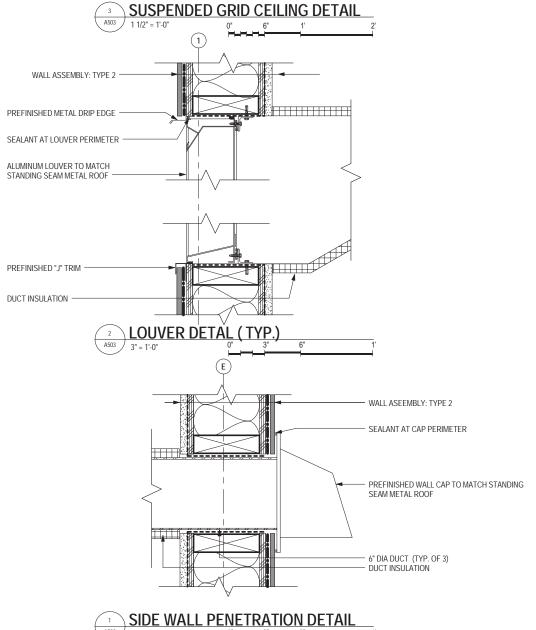

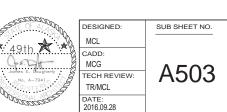


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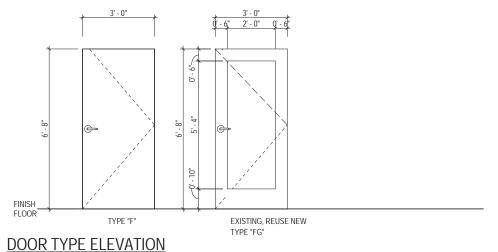
RIM ARCHITECTS 645 G STREET , SUITE 400 ANCHORAGE ,AK 99501 (907 PALMER 111WEST EVERGREEN AVE. PALMER,AK 9964 CORPORATE NO. AECL1227.			
TITLE OF SHEET	DRAWING NO		
DETAILS	186		
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	PMIS/PKG NC		
	184638		
SEWARD VISITOR CENTER REHAB	SHEET		
KENAI FJORDS NATIONAL PARK	26 of 73		

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OPENING SCHEDULE												
DOOR							FRAME			FIRE		
				SIZE				G		GLAZING	RATING	
OPENING	NAME	TYPE	WIDTH	HEIGHT	MAT	FINISH	TYPE	MAT	FINISH	TYPE	(MINUTES)	COMMENTS
101A	MAIN EXHIBIT SPACE	FG	3' - 0"	6' - 8"	IHM	PAINT	INSUL	HM	PAINT	SG		
101B	EAST HALL	EXISTING	3' - 0"	6' - 8"	EXIST HM	PAINT	~	EXIST HM	PAINT	SG		REUSE EXISTING DOOR AND FRAME FROM E07
102	HALLWAY	EXISTING	3' - 0"	6' - 8"	EXIST WD	REFINISH		EXIST WD	PAINT			REUSE EXISTING DOOR AND FRAME FROM E08
103	MEN'S RESTROOM	EXISTING	3' - 0"	6' - 8"	EXIST WD	REFINISH		EXIST WD	PAINT			REUSE EXISTING DOOR AND FRAME FROM E10
104	WOMEN'S RESTROOM	EXISTING	3' - 0"	6' - 8"	EXIST WD	REFINISH		EXIST WD	PAINT			REUSE EXISTING DOOR AND FRAME FROM E14
105	JANITOR	EXISTING	3' - 0"	6' - 8"	EXIST WD	REFINISH		EXIST WD	PAINT			REUSE EXISTING DOOR AND FRAME FROM E11
106	SOUTH HALL	EXISTING	3' - 0"	6' - 8"	EXIST WD	REFINISH		EXIST WD	PAINT			REUSE EXISTING DOOR AND FRAME FROM E16
107A	VEST	F	3' - 0"	6' - 8"	WD	STAIN		HM	PAINT		60	
107B	VEST	F	3' - 0"	6' - 8"	IHM	PAINT	INSUL	HM	PAINT			
108	AK GEO	F	3' - 0"	6' - 8"	WD	STAIN		HM	PAINT		60	
109	THEATER	EXISTING	3' - 0"	6' - 8"	EXIST WD	REFINISH		EXIST WD	PAINT			REUSE EXISTING DOOR AND FRAME FROM E15
110	MECHANICAL	F	3' - 0"	6' - 8"	IHM	PAINT		HM	PAINT			
111	STORAGE	EXISTING	3' - 0"	6' - 8"	EXIST WD	REFINISH		EXIST WD	PAINT			REUSE EXISTING DOOR AND FRAME FROM E05
112	SERAC STORAGE	EXISTING	3' - 0"	6' - 8"	EXIST WD	REFINISH		EXIST WD	PAINT			REUSE EXISTING DOOR AND FRAME FROM E17
113A	STORAGE	F	3' - 0"	6' - 8"	IHM	PAINT	INSUL	HM	PAINT			
113B	STORAGE	F	3' - 0"	7' - 0"	IHM	PAINT		HM	PAINT		60	
203	OFFICE	EXISTING	3' - 0"	6' - 8"	EXIST WD	REFINISH		EXIST WD	REFINISH			REUSE EXISTING DOOR AND FRAME FROM E13
209	RESTROOM	EXISTING	3' - 0"	6' - 8"	EXIST WD	REFINISH		EXIST WD	REFINISH			REUSE EXISTING DOOR AND FRAME FROM E01
210	STAIR	F	3' - 0"	6' - 8"	WD	STAIN		HM	PAINT		60	




# WINDOW TYPE ELEVATION

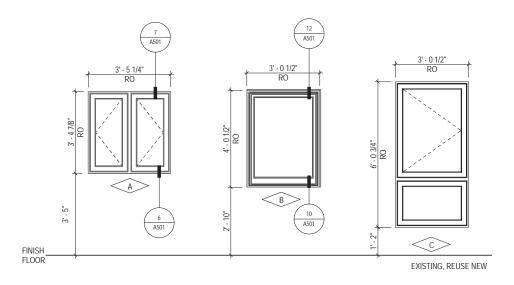

# REFER TO SPECIFICATIONS 087100 DOOR HARDWARE FOR REUSE OF EXISTING HARDWARE COMPONENTS. REPAIR ABANDONED HOLES IN DOORS AND PREPARE FOR NEW FINISH. PLACE CLOSERS ON SIDE OF DOOR INDICATED IN OPENING SCHEDULE. EXCHANGE WITH OTHER AVAILABLE CLOSERS TO ACHIEVE THIS CRITERIA.


**GENERAL OPENING SCHEDULE NOTES:** 

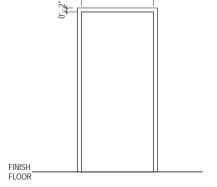

# FRAME TYPE ELEVATION

RIM ARCHITECTS 645 G STREET ,SUITE 400 ANCHORAGE ,AK 99501 (907)-258-7777 PALMER 111WEST EVERGREEN AVE. PALMER,AK 99645 (907)-258-7777 CORPORATE NO. AECL1227.

DRAWING NO.

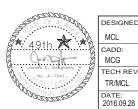

	DESIGNED:	SUB SHEET NO.
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í	MCG	1004
	TECH REVIEW:	Abul
	TR/MCL	
	DATE:	


TITLE OF SHEET DOOR SCHEDULE


80,040 PMIS/PKG NO. 184638 SHEET SEWARD VISITOR CENTER REHAB KENAI FJORDS NATIONAL PARK 27 of 73

# **INTERIOR FINISH LEGEND:**

	CODE	MATERIAL	MANUFACTURER	STYLE	COLOR/FINISH	SIZE	NOTES
8	CPT-1	CARPETING	INTERFACE	PLATFORM 1467200250H	9336 STRATOSPHERE		FIRST FLOOR FIELD COLOR
FLOOR	CPT-2	CARPETING	INTERFACE	MENAGERIE	4941 CORNFLOWER		FIRST FLOOR ACCENT COLOR
	CPT-3	CARPETING	INTERFACE	SIDETRACK 1468402500	104257 STRATOSPHERE/ TRACK		SECOND FLOOR COLOR- BRICK INSTALL
	RESIL-1	RESILIENT FLOORING	MANNINGTON	FLOW	CALIBER PAR308		INSTALL INTEGRAL COVE AT BATHROOM LOCATIONS
	RTT-1	RUBBER TIRE TILE					VESTIBULE FLOORING
	SRRF-1	SLIP RESISTANT RUBBER FLOORING	ROPPE		139 DEEP NAVY		
ų	WD-1	WOOD BASE	REUSE EXISTING	REUSE EXISTING	PAINT AND REINSTALL		*CONTRACTOR HAS OPTION TO REMOVE AND REINSTALL OR PAINT IN PLACE WHERE SPECIFIED ON ROOM FINISH SCHEDULE
BASE	RB-1	RESILIENT BASE	ROPPE		139 DEEP NAVY	4"	
	RCB-1	RESILIENT COVE BASE	MANNINGTON	FLOW	CALIBER PAR308		INSTALL INTEGRAL COVE AT BATHROOM LOCATIONS
	P-1	PAINT	SHERWIN WILLIAMS	LOW LUSTER	TO BE DETERMINED		
WALL	P-2	PAINT	SHERWIN WILLIAMS	LOW LUSTER	SW 6989 DOMINO		1' - 0" HORIZONTAL BAND, WOOD BASE AND DOOR TRIM ON FIRST FLOOR
	P-3	PAINT	SHERWIN WILLIAMS	LOW LUSTER	SW 6488 GRAND CANAL		SOUTH HALL WALLS
	P-4	PAINT	SHERWIN WILLIAMS	LOW LUSTER	SW 7666 FLEUR DE SEL		
	CPT-4	CARPETING			TO BE DETERMINED		INSTALLED TO 4'-0" AFF ON THE WALL IN THE THEATER ROOM- WITH CHAIR RAIL
	PL-1	PLASTIC LAMINATE	FROMICA	WHITE DROPS	8824-58	4' X 8'	INSTALL OVER PLYWOOD SUBSTRATE W/ BALANCING SHEET
O	P-5	PAINT	SHERWIN WILLIAMS	LOW LUSTER	SW 7007 CEILING BRIGHT WHITE		GYPSUM CEILINGS
CEILING							
SNO	SS-1	SOLID SURFACE	CORIAN	TERRA COLLECTION	SILVER BIRCH		
MISCELLANEOUS							
SCE							
≥							

ROOM FINISH SCHEDULE										
			BAS	SE		WA				
ROOM NUMBER	ROOM NAME	FLOOR FINISH	MATERIAL	HEIGHT	NORTH FINISH	EAST FINISH	SOUTH FINISH	WEST FINISH	CEILING FINISH	COMMENTS
00	STAIR	SRRF-1	RB-1	4"	P-4	P-4	P-4	P-4	P-5	
01A	MAIN EXHIBIT SPACE	CPT-1/CPT-2	WD-1	4"	P-1/P-2	P-1/P-2	P-1/P-2	P-1/P-2	P-2 / OPEN GRID	5 , 4
01B	SOUTH HALL	CPT-1/CPT-2	WD-1	4"	P-1/P-3	P-1/P-3	P-1/P-3	P-1/P-3	P-5	5 , 4
01C	EAST HALL	CPT-1/CPT-2	WD-1	4"	P-1/P-2	P-1/P-2	P-1/P-2	P-1/P-2	P-5	5,4
02	EDUCATION	CPT-1	WD-1	4"	P-1	P-1	P-1	P-1	P-5	
03	MEN'S RESTROOM	RESIL-1	RCB-1	4"	PL-1/ P-4	PL-1 / P-4	PL-1 / P-4	PL-1 / P-4	P-5	6
04	WOMEN'S RESTROOM	RESIL-1	RCB-1	4"	PL-1/ P-4	PL-1 / P-4	PL-1 / P-4	PL-1 / P-4	P-5	6
05	JANITOR	RESIL-1	RB-1	4"	P-4	P-4	P-4	P-4	P-5	
06	STORAGE	RESIL-1	RB-1	4"	P-4	P-4	P-4	P-4	P-5	
07	VEST	RTT-1	RB-1	4"	P-4	P-4	P-4	P-4	P-5	
08	AK GEO	CPT-1	WD-1	4"	P-4	P-4	P-4	P-4	P-5	
109	THEATER	CPT-1	WD-1	4"	CPT-4/P-1	CPT-4/P-1	CPT-4/P-1	CPT-4/P-1	P-5	
10	MECHANICAL	RESIL-1	RB-1	4"	P-4	P-4	P-4	P-4	P-5	
11	STORAGE	RESIL-1	RB-1	4"	P-4	P-4	P-4	P-4	P-5	
12	SERAC STORAGE	CPT-1	WD-1	4"	P-1	P-1	P-1	P-1	P-5	
13	STORAGE	RESIL-1	RB-1	4"	P-4	P-4	P-4	P-4	P-5	
14	HALLWAY	CPT-1	WD-1	4"	P-1	P-1	P-1	PL-1/ P-4	P-5	6
201	CIRCULATION	CPT-3	WD-1	4"	P-4	P-4	P-4	P-4	P-5	1,3,5
202	OFFICE	CPT-3	WD-1	4"	P-4	P-4	P-4	P-4	P-5	1,2
203	OFFICE	CPT-3	WD-1	4"	P-4	P-4	P-4	P-4	P-5	1,5
204	OFFICE	CPT-3	WD-1	4"	P-4	P-4	P-4	P-4	P-5	1,5
205	OFFICE	CPT-3	WD-1	4"	P-4	P-4	P-4	P-4	P-5	1,5
206	STORAGE	CPT-3	WD-1	4"	P-4	P-4	P-4	P-4	P-5	1
07	LOCKERS	CPT-3	WD-1	4"	P-4	P-4	P-4	P-4	P-5	1
108	CONFERENCE	CPT-3	WD-1	4"	P-4	P-4	P-4	P-4	P-5	1,5,6
109	RESTROOM	RESIL-1	RCB-1	4"	PL-1/ P-4	PL-1 / P-4	PL-1 / P-4	PL-1 / P-4	P-5	
210	STORAGE	CPT-3	WD-1	4"	P-4	P-4	P-4	P-4	P-5	
211	HALL	CPT-3	WD-1	4"	P-4	P-4	P-4	P-4	P-5	
4	ELEV	CPT-3	WD-1	4"	~	~	~	~	~	

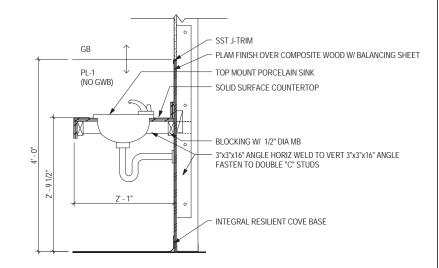

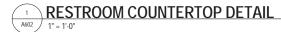

# **ROOM FINISH NOTES**

- PATCH AND PAINT CEILING WHERE MECHANICAL WORK HAS OCCURRED. REFER TO MECHANICAL DRAWINGS MATCH EXISTING CONDITIONS.
   PATCH AND PAINT WALLS WHERE EXTERIOR WALL CONSTRUCTION HAS OCCURED MATCH EXISTING.
- CONDITIONS.
- CONDITIONS.

  3. PAINT AREAS OF NEW CONSTRUCTION MATCH EXISTING CONDITIONS.

  4. 1'-0" (APPROX.) P-2 BAND FROM 7'-0" AFF TO UNDERSIDE OF CEILING . REFER A150 TO SHEETS A103 AND A104 FOR ADDITIONAL INFORMATION.

  5. REFER TO SHEETS A103 AND A104 FOR CARPET PATTERNS.

  6. PLASTIC LAMINATE WAINSCOT TO 4'-0" WITH SS TRIM- REFER TO INTERIOR ELEVATIONS

RIM ARCHITECTS 645 G STREET ,SUITE 400 ANCHORAGE ,AK 99501 (907)-258-7777 PALMER 111WEST EVERGREEN AVE. PALMER,AK 99645 (907)-258-7777 CORPORATE NO. AECL1227. DESIGNED: SUB SHEET NO. TITLE OF SHEET FINISH SCHEDULE CADD: MCG

DRAWING NO. 186 80,040 PMIS/PKG NO. 184638 SHEET SEWARD VISITOR CENTER REHAB KENAI FJORDS NATIONAL PARK 28 of 73

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THE CONTRACTOR SHALL VERIFY AND COORDINATE ALL DIMENSIONS AMONG THE DRAWINGS BEFORE STARTING WORK OR FABRICATION. IN CASE OF DISCREPANCIES BETWEEN DRAWINGS. SPECIFICATIONS, REFERENCE STANDARDS, SITE CONDITIONS OR GOVERNING CODE, THE MORE STRINGENT REQUIREMENTS SHALL GOVERN. CONTRACTOR SHALL NOTIFY THE CONTRACTING OFFICER OF DISCREPANCIES AND OBTAIN DIRECTION PRIOR TO PROCEEDING. NOTES ON INDIVIDUAL STRUCTURAL DRAWINGS SHALL TAKE PRIORITY OVER GENERAL STRUCTURAL NOTES. NOTED DIMENSIONS TAKE PRECEDENCE OVER SCALED DIMENSIONS, DO NOT SCALE DRAWINGS. TYPICAL DETAILS MAY NOT NECESSARILY BE INDICATED ON THE PLANS, BUT SHALL APPLY AS SHOWN OR DESCRIBED IN THE DETAILS.

ALL CONSTRUCTION SHALL COMPLY WITH THE 2012 INTERNATIONAL BUILDING CODE (IBC) AND THE 2006 IBC AS AMENDED AND ADOPTED BY THE CITY OF SEWARD, AK.

SAFETY - THE CONTRACTOR IS RESPONSIBLE FOR MEETING ALL FEDERAL, STATE AND LOCAL SAFETY STANDARDS. THE CONTRACTOR IS IN CHARGE OF ALL SAFETY MATTERS ON AND AROUND

CTURAL DESIGN IS IN ACCORDANCE WITH THE IBC AS AMENDED AND ADOPTED BY THE CITY OF SEWARD, OCCUPANCY CATEGORY IS II IN ACCORDANCE WITH IBC SECTION 1604.5.

REFER TO ARCHITECTURAL DRAWINGS FOR ELEVATIONS, SLOPES, DEPRESSIONS, NON-BEARING WALLS, FASCIA, CURBS, DRAINS, RAILINGS, WATERPROOFING, FINISHES, ETC

THE STRUCTURE HAS BEEN DESIGNED FOR THE FOLLOWING OPERATIONAL LOADS ON THE COMPLETED STRUCTURES. CONTRACTOR IS RESPONSIBLE FOR TEMPORARY SHORING AND BRACING DURING CONSTRUCTION.

EXISTING STRUCTURE HAS NOT BEEN STRENGTHENED FOR INCREASED WIND OR SNOW LOADS.

LIVE LOADS: OFFICE AREAS = 50 PSF + 15 PSF PARTITION 1ST FLOOR CORRIDORS & EXITS = 100 PSF CORRIDORS ABV 1ST FLOOR = 80 PSF STORAGE AREAS (LIGHT) = 125 PSF

ORIGINAL ROOF SNOW LOAD: CURRENT ROOF SNOW: 80 PSF BASIC + DRIFT Is=1.0. Pa=80 PSF, Ct=1.0, Ce=1.0

WIND LOADS: BASIC WIND SPEED (3-SECOND GUST, Vasd)=130 MPH EXPOSURE D. Iw=1.0. INTERNAL PRESSURE GCpi=±0.55

SEISMIC LOADS: SITE CLASS D. DESIGN CATEGORY D Ss=1.78, S1=0.67, Sds=1.19, Sd1=0.67, le=1.0

LATERAL ANALYSIS IS LINEAR STATIC. LATERAL FORCES ARE CARRIED BY FLEXIBLE ROOF AND FLEXIBLE FLOOR DIAPHRAGMS TO THE WOOD SHEARWALLS. MOMENTS, SHEARS, AND ROTATIONAL FORCES ARE DELIVERED TO THE FOUNDATION BY THE WOOD SHEARWALLS IN PROPORTION TO THEIR TRIBUTARY AREA.

 $\frac{\hbox{FOUNDATIONS}}{\hbox{FOUNDATIONS}} \text{ARE DESIGNED FOR A MAXIMUM SOIL BEARING PRESSURE OF 3000 PSF UNDER}$ SUSTAINED LOADING

WARM FOOTINGS SHALL BE FOUNDED AT LEAST 42-INCHES BELOW LOWEST ADJACENT EXTERIOR FINISHED GRADE, FOOTING DEPTHS AND ELEVATIONS SHOWN ARE MINIMUM AND FOR GUIDANCE ONLY; CONTRACTOR SHALL ESTABLISH ACTUAL ELEVATIONS IN FIELD.

ALL ORGANIC FROZEN OR OTHER LINSUITABLE MATERIALS SHALL BE REMOVED FROM SUB-GRADE AND REPLACED WITH COMPACTED GRANULAR NON-FROST SUSCEPTIBLE (NFS) FILL. ALL FOOTINGS SHALL BE FOUNDED UPON UNDISTURBED, NATURAL SUB-GRADE OR COMPACTED NFS FILL WITH A MINIMUM ALLOWABLE BEARING CAPACITY OF 3000 PSF

SUB-GRADES BENEATH FOOTINGS AND SLABS SHALL BE COMPACTED TO A MINIMUM OF 95 PERCENT OF THE MAXIMUM DRY DENSITY AS MEASURED BY ASTM D1557. BACKFILL AROUND AND ABOVE ALL FOUNDATION ELEMENTS SHALL BE COMPACTED TO A MINIMUM OF 90 PERCENT OF MAXIMUM DRY DENSITY

EXISTING CONDITIONS
CONTRACTOR SHALL VERIFY ALL EXISTING DIMENSIONS, MEMBER SIZES, AND CONDITIONS PRIOR TO COMMENCING ANY WORK. ALL DIMENSIONS OF EXISTING CONSTRUCTION SHOWN ON THE DRAWINGS ARE INTENDED AS GUIDELINES ONLY AND MUST BE VERIFIED. EXISTING CONDITIONS SHOWN ON DRAWINGS ARE BASED EITHER ON SITE OBSERVATIONS, ORIGINAL DRAWINGS, OR WERE ASSUMED BASED ON EXPECTED CONDITIONS. IF EXISTING CONDITIONS DO NOT CLOSELY MATCH CONDITIONS SHOWN ON DRAWINGS, OR IF EXISTING MATERIALS ARE OF QUESTIONABLE OR SUBSTANDARD QUALITY, NOTIFY CONTRACTING OFFICER PRIOR TO COMMENCING WORK.

THE OWNER SHALL ENGAGE A SPECIAL INSPECTOR PER CHAPTER 17 OF THE IBC 2006. SEE STATEMENT OF SPECIAL INSPECTIONS ON SHEET S002. COPIES OF INSPECTION REPORTS SHALL BE AVAILABLE TO THE CONSTRUCTION SITE FOR REVIEW BY THE CONTRACTING OFFICER

<u>DEFERRED SUBMITTALS</u>
THE FOLLOWING ITEMS ARE NOT INCLUDED IN THESE DRAWINGS AND REQUIRE STRUCTURAL DESIGN TO BE FURNISHED BY THE CONTRACTOR:

SEISMIC ANCHORAGE OF MECHANICAL & ELECTRICAL EQUIPMENT

DRAWINGS AND CALCULATIONS FOR BUILDER-DESIGNED COMPONENTS, SEALED BY THE ALASKA STATE REGISTERED PROFESSIONAL ENGINEER RESPONSIBLE FOR THE DESIGN, SHALL BE SUBMITTED TO THE CONTRACTING OFFICER FOR REVIEW FOR GENERAL CONFORMANCE TO THE CONTRACT DOCUMENTS PRIOR TO SUBMITTING TO THE CONTRACTING OFFICER FOR REVIEW. SUBMITTALS OF BUILDER-DESIGNED ITEMS SHALL INCLUDE LOCATIONS, MAGNITUDES, AND DIRECTIONS OF ALL FORCES TRANSFERRED TO THE STRUCTURE. DEFERRED SUBMITTALS MUST BE REVIEWED AND APPROVED BY BUILDING SAFETY PRIOR TO INSTALLATION/CONSTRUCTION.

THE CONTRACTOR SHALL REVIEW, STAMP WITH HIS APPROVAL, DATE AND SIGN ALL SHOP DRAWINGS AND SUBMITTALS REQUIRED BY THE SPECIFICATION REQUIREMENTS PRIOR TO SUBMITTAL TO THE CONTRACTING OFFICER. AT THE TIME OF SUBMISSION, THE CONTRACTOR SHALL INFORM THE CONTRACTING OFFICER IN WRITING OF ALL DEVIATIONS IN THE SHOP DRAWINGS FROM THE REQUIREMENTS OF THE CONTRACT DRAWINGS. DIMENSIONS AND QUANTITIES ARE CONTRACTOR'S RESPONSIBILITY AND WILL NOT BE REVIEWED.

#### STRUCTURAL CONCRETE

ALL CAST-IN-PLACE CONCRETE SHALL HAVE MINIMUM 28-DAY COMPRESSIVE STRENGTH OF 3,000

PORTLAND CEMENT SHALL CONFORM TO ASTM C150, MAXIMUM AGGREGATE SIZE SHALL BE 3/4 INCH. ALL AGGREGATE SHALL BE NORMAL WEIGHT MATERIAL CONFORMING TO ASTM C33. WATER SHALL MEET ASTM C94, SECTION 4.1.3.

CONCRETE SHALL BE PROPORTIONED TO ACHIEVE A WORKABLE MIX THAT CAN BE PLACED WITHOUT SEGREGATION OR EXCESS FREE SURFACE WATER, COMPLY WITH IBC SECTION 1905 ALL CONCRETE MAY CONTAIN A WATER REDUCING ADMIXTURE MEETING ASTM C494, TYPE A. BEFORE THE ADDITION OF THE WATER REDUCING ADMIXTURE, THE MAXIMUM SLUMP SHALL BE 3-INCHES, MAXIMUM WATER CEMENT RATIO SHALL BE 0.45 FOR FLOOR SLABS AND 0.50 FOR ALL

ALL CONCRETE CONSTRUCTION SHALL CONFORM TO ACI 301, STANDARD SPECIFICATION FOR STRUCTURAL CONCRETE. CONCRETE PLACED DURING COLD WEATHER SHALL CONFORM TO ACI 306. ALL COLD WEATHER CONCRETE AND CONCRETE EXPOSED TO WEATHER SHALL CONTAIN AIR ENTRAINMENT PER ACI 318 TABLE 4.2.1.

THE FOLLOWING MINIMUM CONCRETE COVER SHALL BE PROVIDED FOR REINFORCEMENT FOR CAST-IN-PLACE CONCRETE:

A CONCRETE CAST AGAINST FARTH 3-INCHES B.CONCRETE EXPOSED TO EARTH OR WEATHER 2-INCHES C.CONCRETE NOT EXPOSED TO EARTH OR WEATHER

ALL CONCRETE REINFORCING SHALL BE DETAILED, FABRICATED, LABELED, SUPPORTED AND SPACED IN FORMS AND SECURED IN PLACE IN ACCORDANCE WITH THE LATEST EDITIONS OF ACI 315, ACI 318, CRSI MSP-1 AND ACI SP-66. DOWELS SHALL MATCH SIZE AND NUMBER OF MAIN

TYPICAL REINFORCING BARS SHALL BE ASTM A615, GRADE 60. LAP SPLICES SHALL BE CLASS B LAPS PER ACI (63 X BAR DIAMETER). LAP SPLICES MAY ALSO ACCOMPLISHED USING MECHANICAL DEVICES THAT DEVELOP 125% OF THE STRENGTH OF THE REBAR

CHECKED SHOP DRAWINGS SHOWING REINFORCING DETAILS, INCLUDING STEEL SIZES, SPACING AND PLACEMENT SHALL BE SUBMITTED TO THE CONTRACTING OFFICER FOR REVIEW PRIOR TO

EMBEDDED ITEMS (CONDUIT AND SLEEVES) SHALL NOT BE EMBEDDED IN OR PASS THROUGH CONCRETE WITHOUT APPROVAL. ALUMINUM ITEMS SHALL NOT BE EMBEDDED IN CONCRETE. SUBMIT CONDUIT LAYOUT AND EMBEDDED ITEM PLANS FOR REVIEW PRIOR TO PLACING CONCRETE.

INSTALLATION SHALL CONFORM TO MANUFACTURER'S INSTRUCTIONS AND REQUIREMENTS OF ICC-ES REPORT. ALL POST-INSTALLED ANCHORS SHALL HAVE A CURRENT ICC-ES REPORT AND BE AUTHORIZED FOR USE IN SEISMIC DESIGN CATEGORY D. PERIODIC SPECIAL INSPECTION IS REQUIRED FOR ALL ADHESIVE ANCHORS, UON

THREADED ROD SHALL BE ASTM A307, UON (OR ISO898 CLASS 5.8), TENSILE STRENGTH OF 60 KSI MIN, AND GALVANIZED WHERE EXPOSED TO THE WEATHER.

EXISTING BASE SHALL BE SCANNED PRIOR TO DRILLING HOLES. EXISTING REBAR LOCATIONS SHALL BE MARKED, AND NEW ANCHOR LOCATIONS REVISED TO AVOID EXISTING REINFORCING NO REINFORCING BARS SHALL BE CUT TO INSTALL ANCHORS. ALL DEFECTIVE ANCHOR HOLES SHALL BE GROUTED AND A NEW HOLE DRILLED A MINIMUM OF 3 BOLT DIAMETERS AWAY

ADHESIVE ANCHORS FOR THREADED ROD AND REBAR SHALL BE ONE OF THE FOLLOWING (OR AN APPROVED EQUIVALENT): CONCRETE:

-SIMPSON "SET-XP" (ESR-2508) -HILTI "HIT-HY 200 SAFE SET" (ESR-3187) -EPCON "S7" (ESR-2308)

EXPANSION ANCHORS SHALL BE ONE OF THE FOLLOWING (OR AN APPROVED EQUIVALENT) CONCRETE:

-HILTI "KWIK BOLT TZ" (ESR-1917) -ITW REDHEAD "TRUBOLT +" (ESR-2427) SIMPSON "STRONG-BOLT 2" (ESR-3037)

SCREW ANCHORS IN CONCRETE SHALL BE ONE OF THE FOLLOWING (OR AN APPROVED EQUIVALENT)

-HII TI "KWIK HUS-F7" (FSR-302) SIMPSON "TITEN HD" (ESR-271) -ITW "TAPCON" (ESR-2202) -POWERS "WEDGE-BOLT+" (ESR-2526)

POWDER- OR POWDER-ACTUATER FASTENERS (PAF) SHALL NOT BE USED TO RESIST LATERAL LOAD INDUCED BY AN EARTHQUAKE. PAF SHALL BE 0.148-INCHES IN DIAMETER AND THE ANCHOR TYPE AND POWDER LOAD SHALL BE SUITED TO THE MATERIAL BEING FASTENED AND THE SUBSTRATE MATERIAL. PRODUCT SHALL BE ITW RAMSET/RED HEAD (ESR-1799, 1955 OR 2579) OR APPROVED EQUAL. SPECIAL INSPECTION IS NOT REQUIRED FOR PAF INSTALLATION.

### STRUCTURAL STEEL

MISC SHAPES & PLATE ASTM A36 ASTM F1554, GRADE 36 ANCHOR RODS:

ALL DETAILING, FABRICATION AND ERECTIONS SHALL CONFORM TO AISC SPECIFICATIONS AND CODES, LATEST EDITION. FABRICATOR MUST PARTICIPATE IN THE AISC QUALITY CERTIFICATION

PROGRAM OR SPECIAL INSPECTIONS MUST BE PROVIDED IN THE FABRICATION SHOP.

ALL WELDING SHALL BE DONE BY QUALIFIED WELDERS AND SHALL CONFORM TO THE AWS D1.1 AND D1.8, LATEST EDITIONS. ALL WELDING ELECTRODES SHALL BE PROPERLY CONDITIONED 70 KSI MINIMUM TENSILE STRENGTH, WITH DIFFUSED HYDROGEN LEVELS OF 16ml/g (H16) OR LESS IN

WELDS NOT SPECIFIED SHALL BE SHOP-PERFORMED CONTINUOUS OR ALL-AROUND 3/16" FILLET

THERE SHALL BE NO FIELD CUTTING OF STRUCTURAL STEEL MEMBERS FOR THE WORK OF OTHER TRADES WITHOUT THE PRIOR APPROVAL OF THE CONTRACTING OFFICER

ALL BEAMS, JOISTS AND TRUSSES SHALL BE FABRICATED WITH THE NATURAL CAMBER UP PROVIDE CAMBERS AS INDICATED ON THE DRAWINGS.

THE CONTRACTOR SHALL BE RESPONSIBLE FOR THE CONTROL OF ALL ERECTION PROCEDURES AND SEQUENCES. CONSIDERATION SHOULD BE GIVEN TO TEMPERATURE DIFFERENTIALS, ESPECIALLY WITH RESPECT TO STRUCTURAL STEEL FRAMING INTO CONCRETE WALLS, BEAMS,

THE CONTRACTOR SHALL SUBMIT SHOP DRAWINGS TO THE CONTRACTING OFFICER FOR REVIEW. THESE DRAWINGS SHALL BE CHECKED BY THE CONTRACTOR BEFORE SUBMITTAL AND SHALL SHOW SHOP FABRICATION DETAILS, FIELD ASSEMBLY DETAILS, AND ERECTION DIAGRAMS FOR ALL STRUCTURAL STEEL. ALSO SUBMIT WELDERS QUALIFICATIONS.

### STRUCTURAL TIMBER

DIMENSIONAL LUMBER: HEM-FIR NO. 2 OR BETTER GLUE-LAMINATED TIMBER: DF/DF, 24F-V4, INDUSTRIAL GRADE ENGINEERED LUMBER: 1.9E LVL, 2.0E PSL POST AND HEAVY TIMBERS: DOUG-FIR NO. 1 FLOOR SHEATHING APA RATED SHEATHING EXPOSURE 1 SPAN RATED 48/24, 3/4-INCH THICK APA RATED SHEATHING, EXTERIOR ROOF SHEATHING: SPAN RATED 40/20 5/8-INCH THICK APA RATED SHEATHING, EXPOSURE 1 WALL SHEATHING:

INSTALL FLOOR AND ROOF SHEATHING WITH THE LONG DIMENSION ACROSS SUPPORTS. ALLOW 1/8-INCH SPACING AT PANEL ENDS AND PANEL EDGES, UNLESS OTHERWISE RECOMMENDED BY THE PANEL MANUFACTURER. ALL FLOOR SHEATHING SHALL BE TONGUE AND GROOVE, GLUED

SPAN RATED 32/16, 1/2-INCH THICK

INSTALL WALL SHEATHING VERTICALLY OR HORIZONTALLY. ALLOW 1/8-INCH SPACING AT PANEL ENDS AND PANEL EDGES, UNLESS OTHERWISE RECOMMENDED BY THE PANEL MANUFACTURER.

SHEATHING SHALL BE USED IN ACCORDANCE WITH THE RECOMMENDATIONS OF APA, THE ENGINEERED WOOD ASSOCIATION. PLACE NAILS 3/8-INCH FROM EDGE OF PANELS

ALL FLOOR AND ROOF DIAPHRAGMS SHALL BE NAILED: PANEL EDGES: 8d NAILS AT 6-INCHES ON-CENTER INTERMEDIATE SUPPORTS: 8d AT 12-INCHES ON-CENTER BLOCKING IS NOT REQUIRED.

THERE SHALL BE NO FIELD CUTTING OF STRUCTURAL TIMBER MEMBERS FOR THE WORK OF OTHER TRADES WITHOUT THE PRIOR REVIEW OF THE CONTRACTING OFFICER.

ALL NAILS SHALL BE COMMON WIRE NAILS, UNLESS NOTED OTHERWISE. NAILING SHALL CONFORM TO TABLE 2304.9.1 OF THE IBC. MINIMUM NAIL DIMENSIONS ARE AS FOLLOWS:

NAIL SIZE, PENNY WT	LENGTH, INCHES	DIAMETER, INCHES
8d	2-1/2	0.131
10d	3	0.148
16d	3-1/2	0.162

NAILS OR STAPLES SHALL BE DRIVEN FLUSH; HEADS SHALL NOT BE DRIVEN BEYOND TIMBER SURFACE, STANDARD ASTM A307 BOLTS SHALL BE USED IN STD HOLES, WASHERS SHALL BE

WALL STUDS SHALL BE SPACED AT 16-INCHES OC. UON.

WOOD PLATES OR SILLS SHALL BE AWW 2X DIMENSIONAL LUMBER BOLTED TO FOUNDATIONS WITH 5/8-INCH DIAMETER ASTM A307 GALV BOLTS. MINIMUM EMBEDMENT SHALL BE 7-INCHES AND MAXIMUM SPACING SHALL BE 4-FEET ON-CENTER. ANCHOR BOLTS SHALL HAVE 3 INCH X 3 INCH X 1/4 INCH THICK GALV PLATE WASHERS BETWEEN THE SILL PLATE AND THE NUT.

ALL AWW SHEATHING AND LUMBER MUST BE PRESSURE TREATED IN ACCORDANCE WITH THE AWPB-FDN OR AWPA U1 STANDARD. MEMBERS MORE THAN 8-INCHES ABOVE GROUND NEED NOT IAVE THIS SPECIAL PRESERVATIVE TREATMENT, UON. TIMBER FASTENERS USED TO FASTEN SILL PLATES SHALL BE HOT-DIP GALVANIZED, STAINLESS STEEL, SILICON BRONZE OR COPPER

PRE-MANUFACTURED HARDWARE SHALL BE SIMPSON OR APPROVED EQUAL

#### SHOP-FABRICATED WOOD TRUSSES

WOOD TRUSSES SHALL MEET THE ANSI / TPI 1 NATIONAL DESIGN STANDARD FOR METAL PLATE CONNECTED WOOD TRUSS CONSTRUCTION. TRUSSES SHALL BE HANDLED. INSTALLED. AND BRACED (TEMPORARILY AND PERMANENTLY) IN ACCORDANCE WITH TRUSS PLATE INSTITUTE DSB, "RECOMMENDED DESIGN SPECIFICATION FOR TEMPORARY BRACING OF METAL-PLATE-CONNECTED WOOD TRUSSES," AND BCSI, "BUILDING COMPONENT SAFETY INFORMATION: GUIDE TO GOOD PRACTICE FOR HANDLING, INSTALLING, RESTRAINING & BRACING METAL-PLATE-CONNECTED WOOD

TRUSSES SHALL BE SUPPLIED BY THE MANUFACTURER WITH PLAN, DETAILS, AND ELEVATIONS DEPICTING REQUIRED TEMPORARY AND PERMANENT LATERAL RESTRAINT AND DIAGONAL BRACING SPECIFIC TO THIS PROJECT INCLUDING SPACING, LOCATIONS, SIZES AND CONNECTIONS.

TRUSS DESIGN DRAWINGS SHALL CONFORM TO IBC 2012 SECTION 2303.4. DESIGN TRUSSES FOR THE FOLLOWING LOADS IN ADDITION TO THOSE LISTED IN STRUCTURAL DESIGN DATA

DEAD LOADS: TOP CHORD = BOTTOM CHORD = 5 PSF WIND UPLIFT = 50 PSF (NET)

LIMIT DEFLECTION UNDER TOTAL LOAD TO L/180 AND DEFLECTION UNDER SNOW LOAD TO L/240.

IN ADDITION TO THE ABOVE, THE GABLE END TRUSSES SHALL BE DESIGNED FOR A LATERAL WIND

EACH TRUSS SHALL BE MARKED WITH NOTES SPECIFYING THE DESIGN SNOW LOADING, MAXIMUM

MANUFACTURER TO PROVIDE TRUSSES & DETAILS THAT CAN ACCOMMODATE OPENINGS LARGER THAN THE TRUSS SPACING. ALSO PROVIDE TRUSSES TO ALLOW FOR SIDE ACCESS, PER ARCH. SEE PLANS FOR SPECIFIC LOCATIONS & DIMENSIONS

#### ABBREVIATIONS

(E)	Existing	LAG	Lag Screw
(N)	New	LOC	Location
@	At	LONG	Longitudinal
AB	Anchor Bolts	MAX	Maximum
ADD'L	Additional	MEZZ	Mezzanine
ADH	Adhesive	MFR	Manufacturer
AFF	Above Finish Floor	MIN	Minimum
AHJ	Authority Having Jurisdiction	OC	On-Center
ALT	Alternate	OH	Overhead
AR	Anchor Rod	OPNG	Opening
ARCH	Architect	PL	Plate
BLDG	Building	PLS	Places
BLKG	Blocking	PSF	Pounds-per-square-foot
BM	Beam	PSI	Pounds-per-square-inch
BOT	Bottom	REQ'D	Required
BTWN	Between	RO	Rough Opening
CL	Center-Line	SBN	Shearwall Boundary Nailing
CLR	Clear	SCH	Schedule
COL	Column	SIM	Similar
CONC	Concrete	SQ	Square
CONT	Continuous, Continue	STL	Steel
DBN	Diaphragm Boundary Nailing	T&B	Top and Bottom
EA	Each	T&G	Tongue and Groove
EQ	Equal. Earthquake	T.O.	Top of
ES	Each Side	T.O.B.	Top of Beam
EW	Each Way	T.O.S.	Top of Steel
EXP	Expansion	T.O.W.	Top of Wall
FDN	Foundation	TRANS	Transverse
FF	Finished Floor	TYP	Typical
FOF	Face of Foundation	UON	Unless Otherwise Noted
FOS	Face of Stud	VERT	Vertical
GALV	Galvanized	W	Wide-Flange, Wide
GLB	Glue-Laminated Beam	W.P.	Work Point
HORZ	Horizontal	W/	With
HSS	Hollow Structural Steel	W/C	Water / Cement Ratio
IBC	International Building Code	W/O	Without
INT	Interior	WWR	Welded Wire Reinforcement

ReidMiddleton | TITLE OF SHEET

SUB SHEET NO DESIGNED DDS CADD. DCP S001 TECH REVIEW DDS 2016.28.09

**GENERAL NOTES** 

SEWARD VISITOR CENTER REHAB KENAI FJORDS NATIONAL PARK

PMIS/PKG NO 184638 29 of 73

DRAWING NO

186

80.040

300 B St., Suite 302 Anchorage, AK 99503

hone: 907 562-3439 - www.reidmiddleton.

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No. CE 10371

SPECIAL INSPECTION & TESTING SCHEDULE						
ITEM	C.I.	P.I.	REFERENCE STANDARD	IBC REFERENCE	REMARKS	
GENERAL						
PREFABRICATED ITEMS	Х	х		1704.2	SAME AS SITE WORK UNLESS APPROVED BY BUILDING OFFICIAL	
SITE PREPARATION, FILL PLACEMENT, SOIL COMPACTION		Х		1704.7, TABLE 1704.7	PRIOR TO REQUESTING A BUILDING DEPARTMENT FOUNDATION INSPECTION, THE SOILS ENGINEER SHALL INSPECT AND APPROVE THE FOUNDATION EXCAVATIONS	
WOOD:			NDS 2005; SDPWS 2008; IBC 1707.3 (NOTE 5)			
GRADE STAMPS ON LUMBER & SHEATHING		Х			INCLUDING ENG. LUMBER, I-JOISTS, PREFAB TRUSSES, ETC	
DETAILS OF WOOD FRAMING		Х			BLOCKING, CONNECTIONS, BRIDGING, BEARING, HANGERS	
NAILING OF ALL SHEAR WALLS AND DIAPHRAGMS	Х			1704.6.1	INCLUDING NOMINAL SIZE OF FRAMING AT PANEL EDGES	
SIZES AND LOCATIONS OF ALL HOLDOWNS		Х				
SIZES, LOCATIONS OF ALL STRAPS		Х				
SIZES SPACINGS OF SILL BOLTING	Х					
NAILING ALONG DRAG STRUTS		Х				
ADDITIONAL INSPECTIONS:						
POST INSTALLED ANCHORS AND EPOXY DOWELS	Х					
ROOF CLADDING AND FRAMING CONNECTIONS		Х				
FABRICATION AND INSTALLATION OF WIND-BORNE DEBRIS RESISTANT GLAZING		Х		1609.1.2	COMPLIANCE WITH ASTM E1996	
SCHEDITIE NOTES	-		1	1	1	

### SCHEDULE NOTES:

- 1. ITEMS MARKED WITH AN "X" REQUIRE INSPECTION BY A SPECIAL INSPECTOR, ITEMS INDICATED WITH A "T" REQUIRE TESTING, ITEMS MARKED WITH A "D" REQUIRE SPECIFIC DOCUMENTATION PER AISC.
- 2. C.I. = CONTINUOUS INSPECTION DURING PROGRESS OF WORK BY SPECIAL INSPECTOR.
- P.I. = PERIODIC INSPECTION BY SPECIAL INSPECTOR AS REQUIRED TO CONFIRM CONFORMANCE OF WORK
   NO SPECIAL INSPECTION FOR CONCRETE IS REQUIRED.
- 5. SPECIAL INSPECTION NOT REQUIRED FOR SHEARWALLS OR DIAPHRAGMS, INCLUDING BOLTING, HOLDDOWNS AND OTHER FASTENINGS, WHEN THE SPACING OF NAILS IS MORE THAN 4-INCHES ON-CENTER.

#### STATEMENT OF SPECIAL INSPECTIONS

REFER TO WRITTEN STATEMENT OF STRUCTURAL TESTS AND SPECIAL INSPECTIONS (STSI) IN SPECIFICATION SECTION 01 4000, QUALITY REQUIREMENTS.

SPECIAL INSPECTIONS AND TESTING
THE CONTRACTING OFFICER SHALL ENGAGE A SPECIAL INSPECTOR PER CHAPTER 17 OF THE IBC
2012. SPECIAL INSPECTION AND TESTING OF THE DESIGNATED SEISMIC SYSTEMS AND OTHER BUILDING STRUCTURE COMPONENTS SHALL BE AS OUTLINED IN THE SPECIAL INSPECTIONS AND TESTING SCHEDULE. WHERE REQUIREMENTS OVERLAP, THE MORE STRINGENT IS TO BE USED.

SPECIAL INSPECTION IS NOT REQUIRED FOR COMPONENTS FABRICATED IN A SHOP APPROVED TO PERFORM SUCH WORK WITHOUT SPECIAL INSPECTION.

DISTRIBUTION OF REPORTS
COPIES OF THE SPECIAL INSPECTION AND TEST REPORTS SHALL BE DISTRIBUTED TO THE CONTACTING OFFICER. REPORTS SHALL BE COMPLETED DAILY AND DISTRIBUTED ON A WEEKLY BASIS AND SHALL BE DISTRIBUTED BY THE MONDAY FOLLOWING THE WEEK IN WHICH THE INSPECTION OR TEST WAS COMPLETED. A COPY OF ALL SPECIAL INSPECTION REPORTS, DEFICIENCIES AND CORRECTIVE ACTIONS SHALL BE MAINTAINED AT THE JOB SITE.

### STRUCTURAL OBSERVATIONS

STRUCTURAL OBSERVATIONS ARE NOT REQUIRED FOR THIS PROJECT.

CONTRACTOR STATEMENT OF RESPONSIBILITY
CONTRACTOR SHALL SUBMIT A WRITTEN STATEMENT OF RESPONSIBILITY TO THE CONTRACTING
OFFICER, IN ACCORDANCE WITH IBC 1706. THE STATEMENT SHALL ACKNOWLEDGE AWARENESS OF THE SPECIAL REQUIREMENTS OF THE QUALITY ASSURANCE PLAN; ACKNOWLEDGE THAT CONTROL WILL BE EXERCISED TO OBTAIN CONFORMANCE WITH THE CONSTRUCTION DOCUMENTS; IDENTIFY PROCEDURES FOR EXERCISING CONTROL; THE METHOD AND FREQUENCY OF REPORTING, AND THE DISTRIBUTION OF REPORTS; AND IDENTIFY PERSONS THAT WILL EXERCISE CONTROL AND THEIR QUALIFICATIONS.

4300 B St., Suite 302 Anchorage, AK 99503 ReidMiddleton 4300 B St., Sulle 302 Anchorage, An 93000 Phone: 907 562-3439 - www.reidmiddleton.co orate License #AECC598 Copyright Reid Middleton, Inc. 2016



**S002** 

SUB SHEET NO.

STATEMENT OF SPECIAL **INSPECTIONS** 


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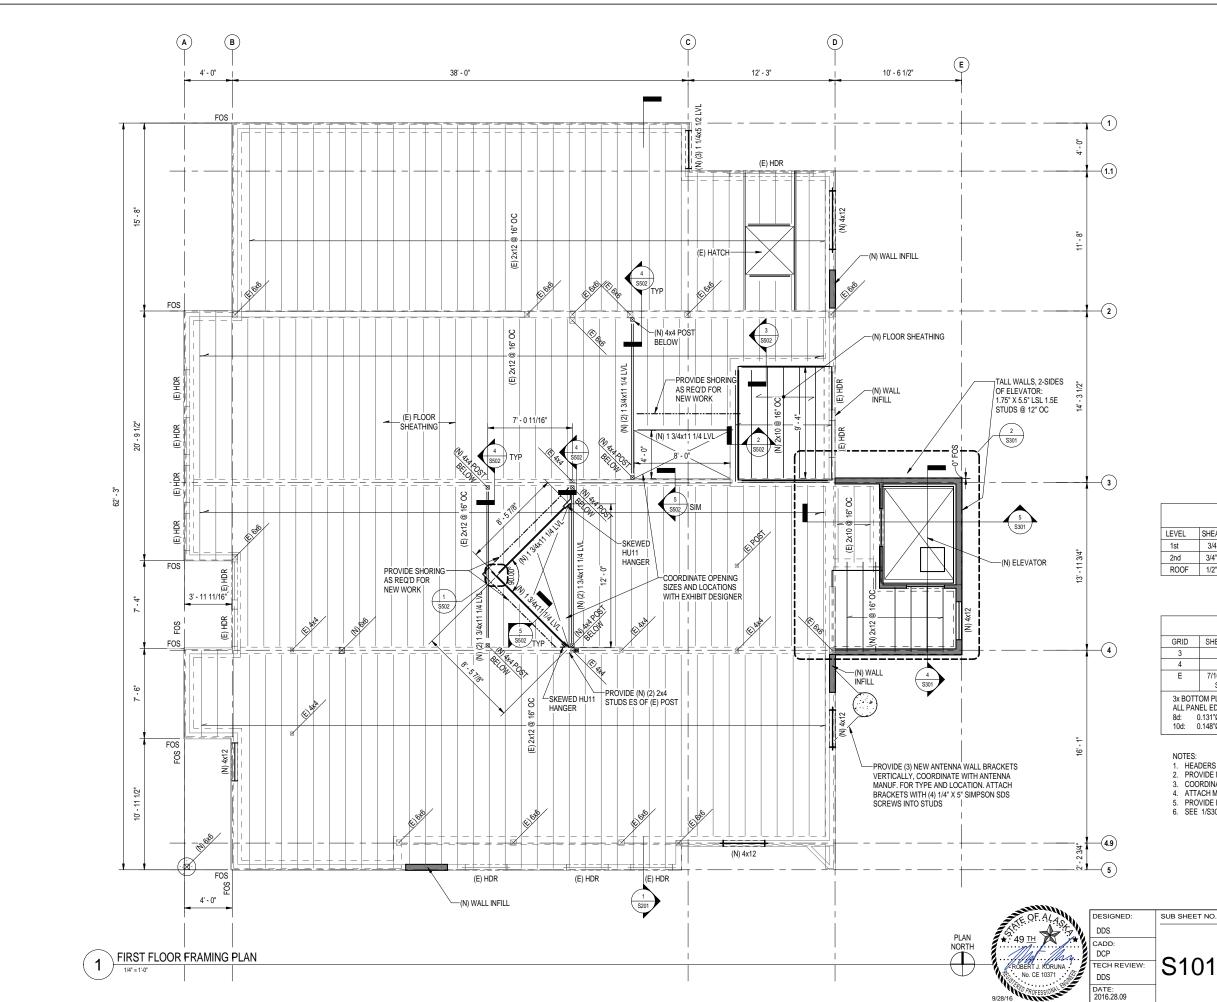
SEWARD VISITOR CENTER REHAB KENAI FJORDS NATIONAL PARK

80.040 PMIS/PKG NO. 184638 SHEET

30 of 73

DRAWING NO. 186



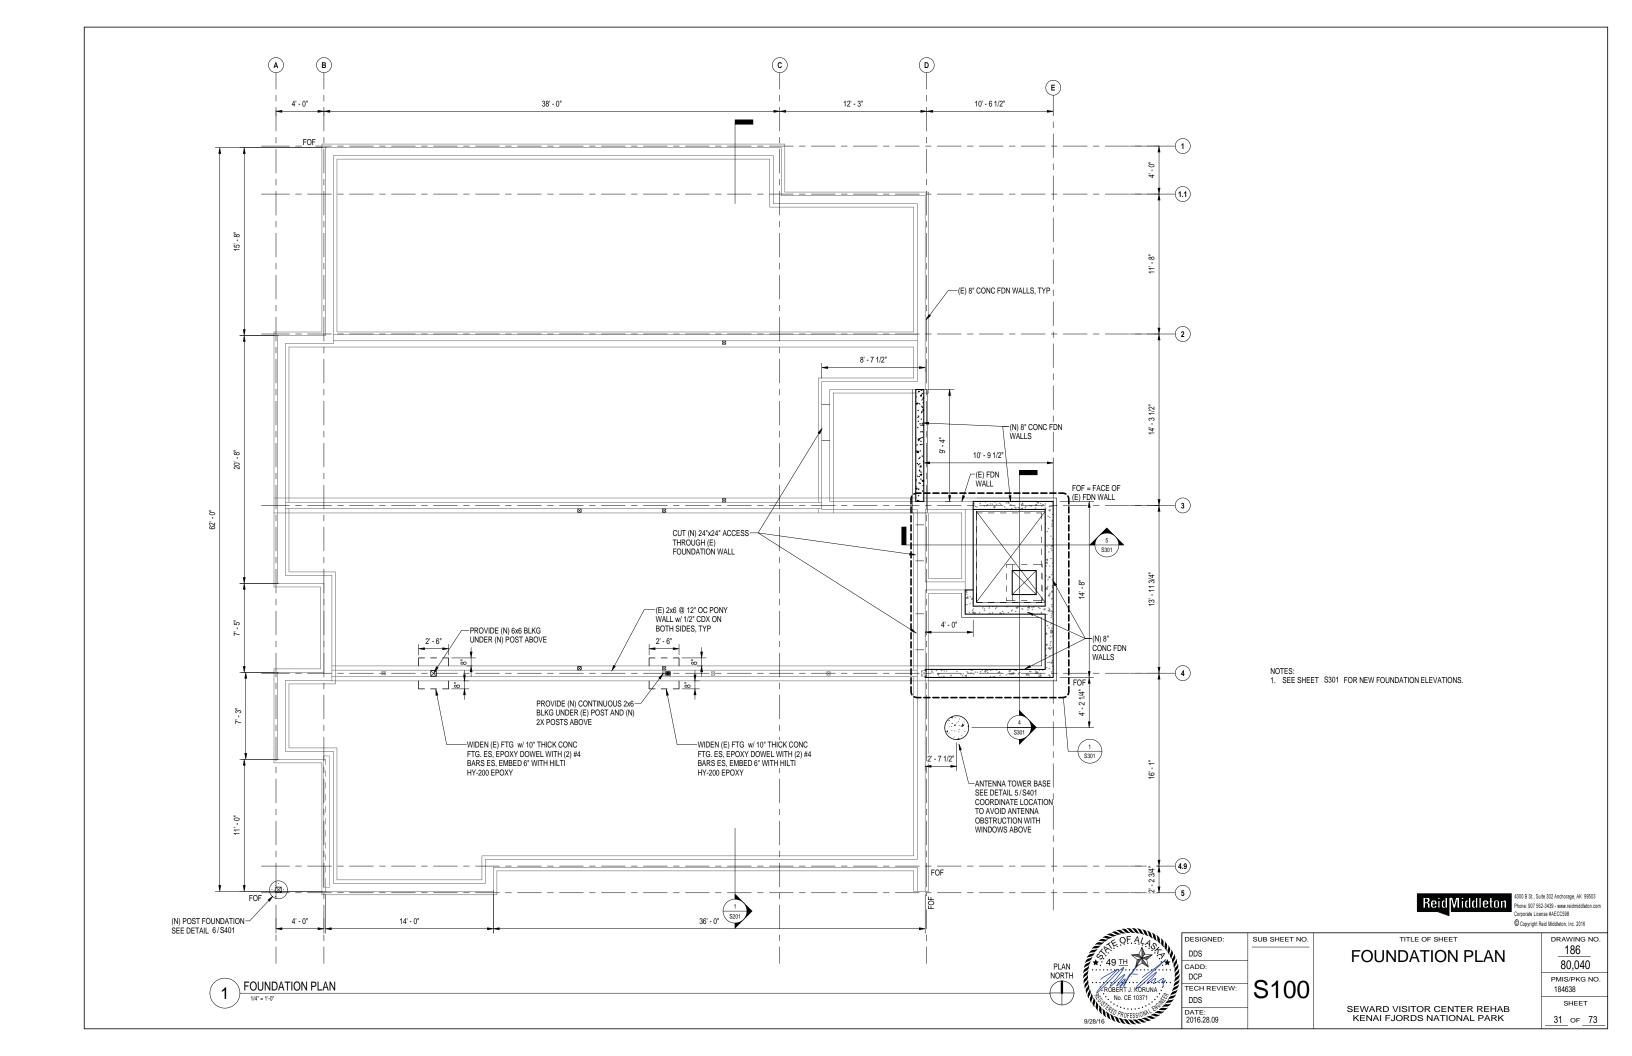



NEW SHEARWALL SCHEDULE						
GRID	SHEATHING	EDGE FASTENING	ANCHOR BOLTS	A35 AT RIM		
3	7/16"	8d @ 3" OC	5/8"Ø @ 32" OC	12" OC		
4	7/16"	8d @ 3" OC	5/8"Ø @ 32" OC	12" OC		
Е	7/16" BOTH SIDES	8d @ 3" OC	5/8"Ø @ 16" OC	6" OC		

3x BOTTOM PLATES REQUIRED FOR ALL NEW SHEARWALLS. FIELD NAIL 12" OC. ALL PANEL EDGES SHALL BE BLOCKED.

8d: 0.131"Ø x 2.5" NAIL
10d: 0.148"Ø x 3.0" NAIL

- NOTES:

  1. HEADERS ON THIS PLAN OCCUR ABOVE 1ST FLOOR WINDOWS & DOORS

  2. PROVIDE NEW STUDS AND OR BLOCKING UNDER ALL NEW FRAMING IN EXISTING AREAS.

  3. COORDINATE LOCATION OF NEW FLOOR OPENINGS WITH EXHIBIT DESIGNER.
- 4. ATTACH MULTI-PLY MEMBERS WITH (4) 10d @ 16° OC.
  5. PROVIDE DOUBLE TRIMMERS AND SINGLE KING POST FOR HEADERS UON.
- 6. SEE 1/S301 FOR HOLDDOWN LOCATIONS.



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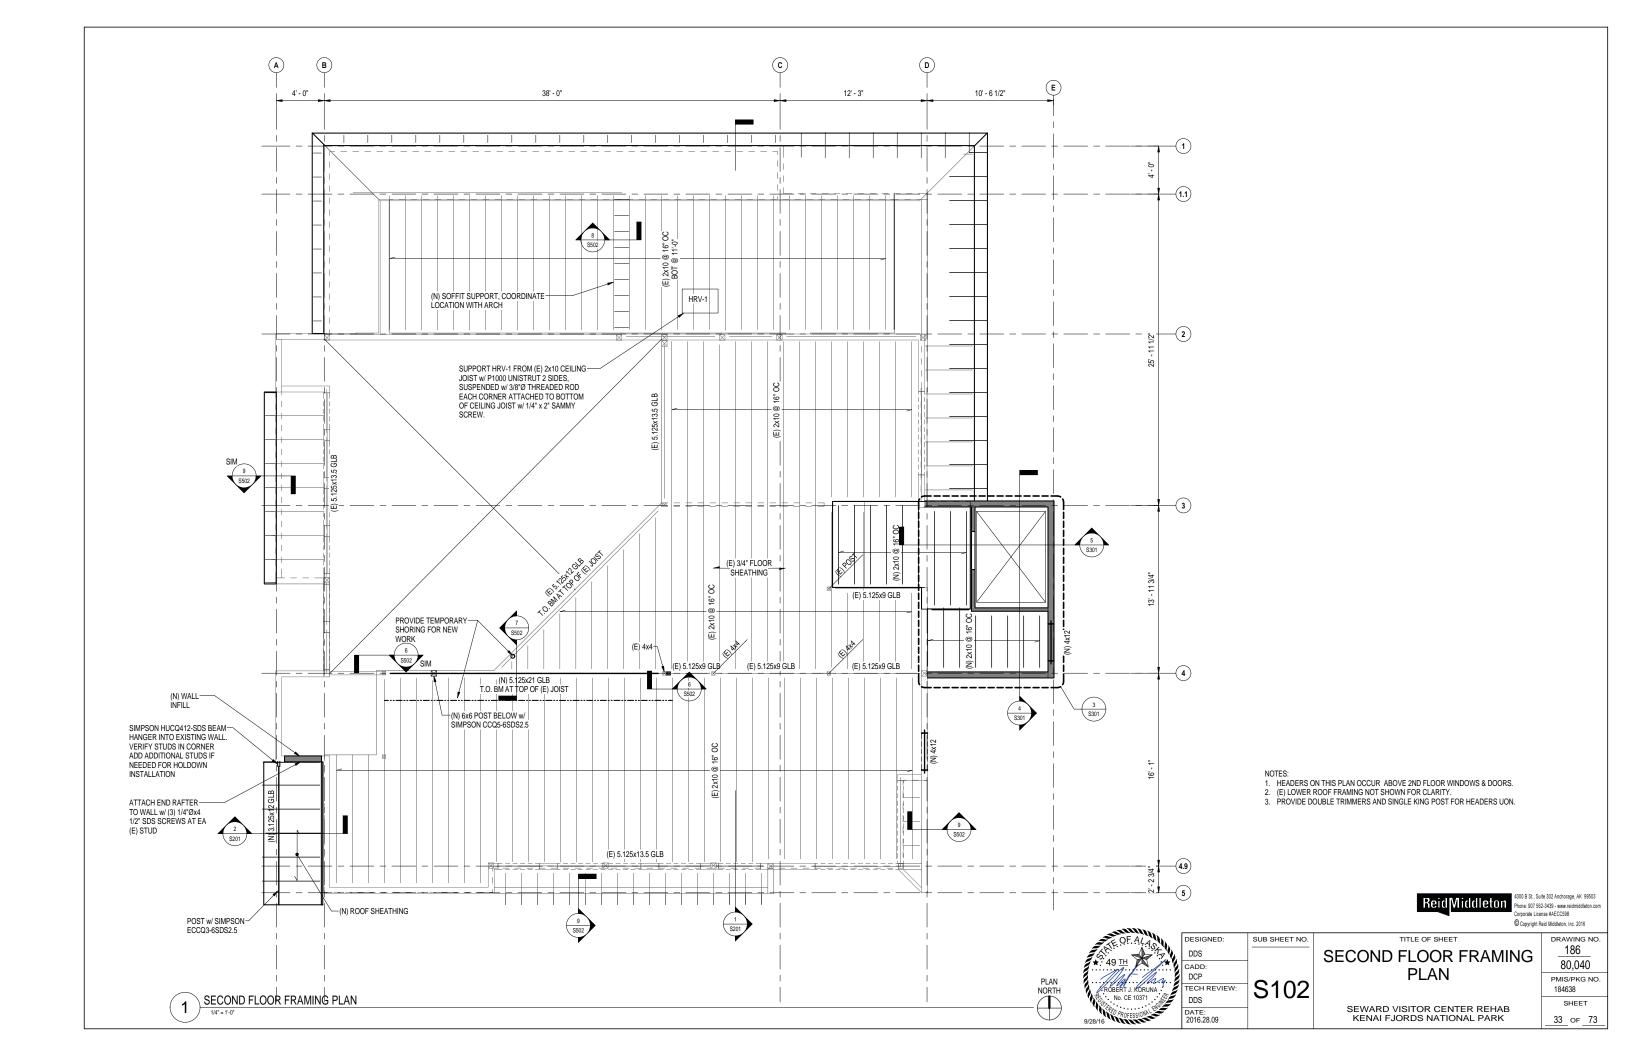
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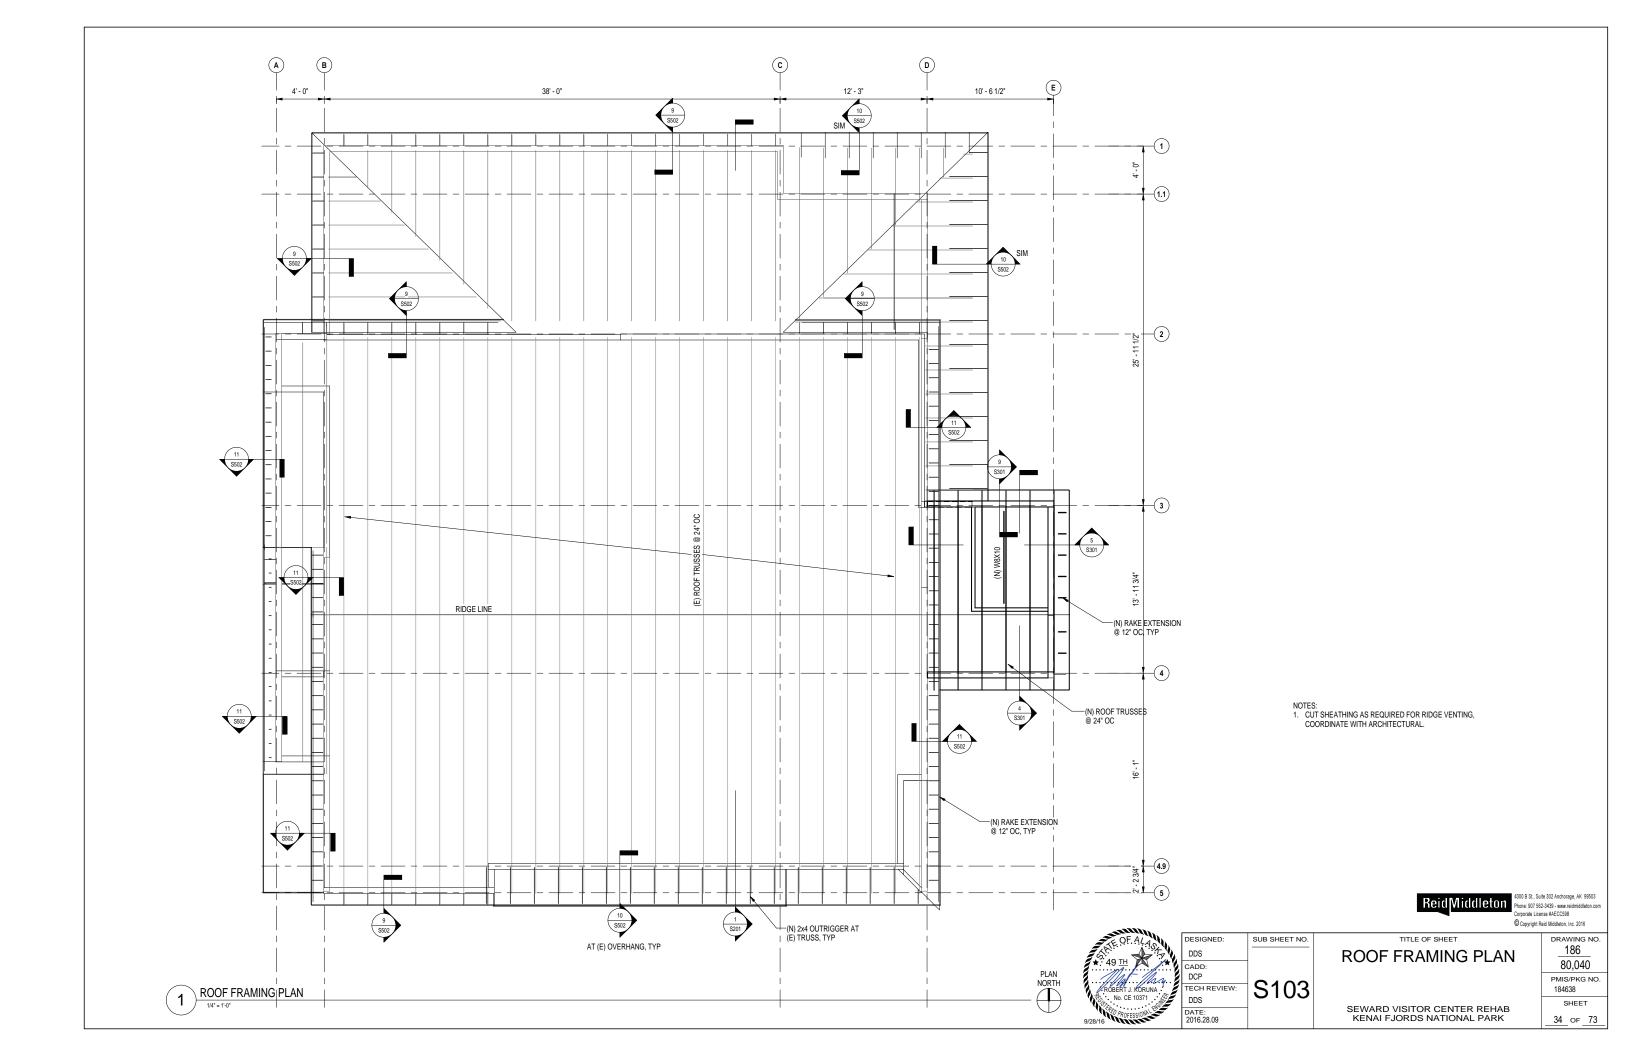
186 80,040 PMIS/PKG NO. 184638


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SEWARD VISITOR CENTER REHAB KENAI FJORDS NATIONAL PARK

SHEET 32 of 73






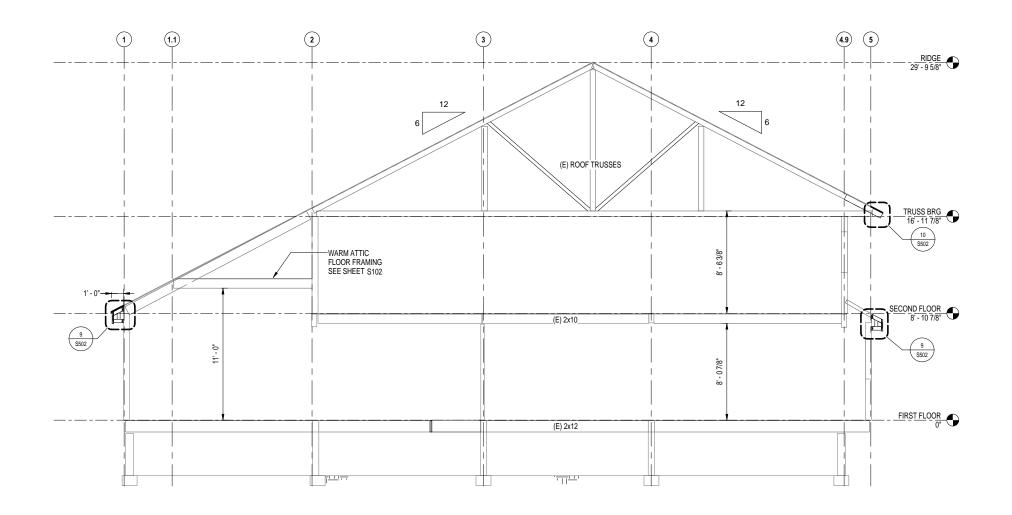

8201 BUILDING SECTION

1/4" = 1'-0"

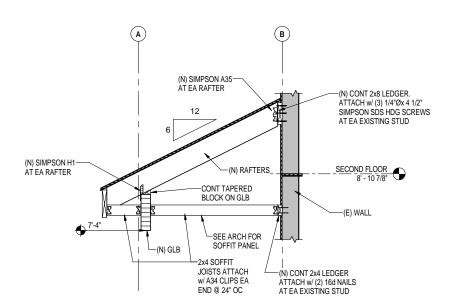

2 NEW CANOPY SECTION
3/4" = 1'-0"

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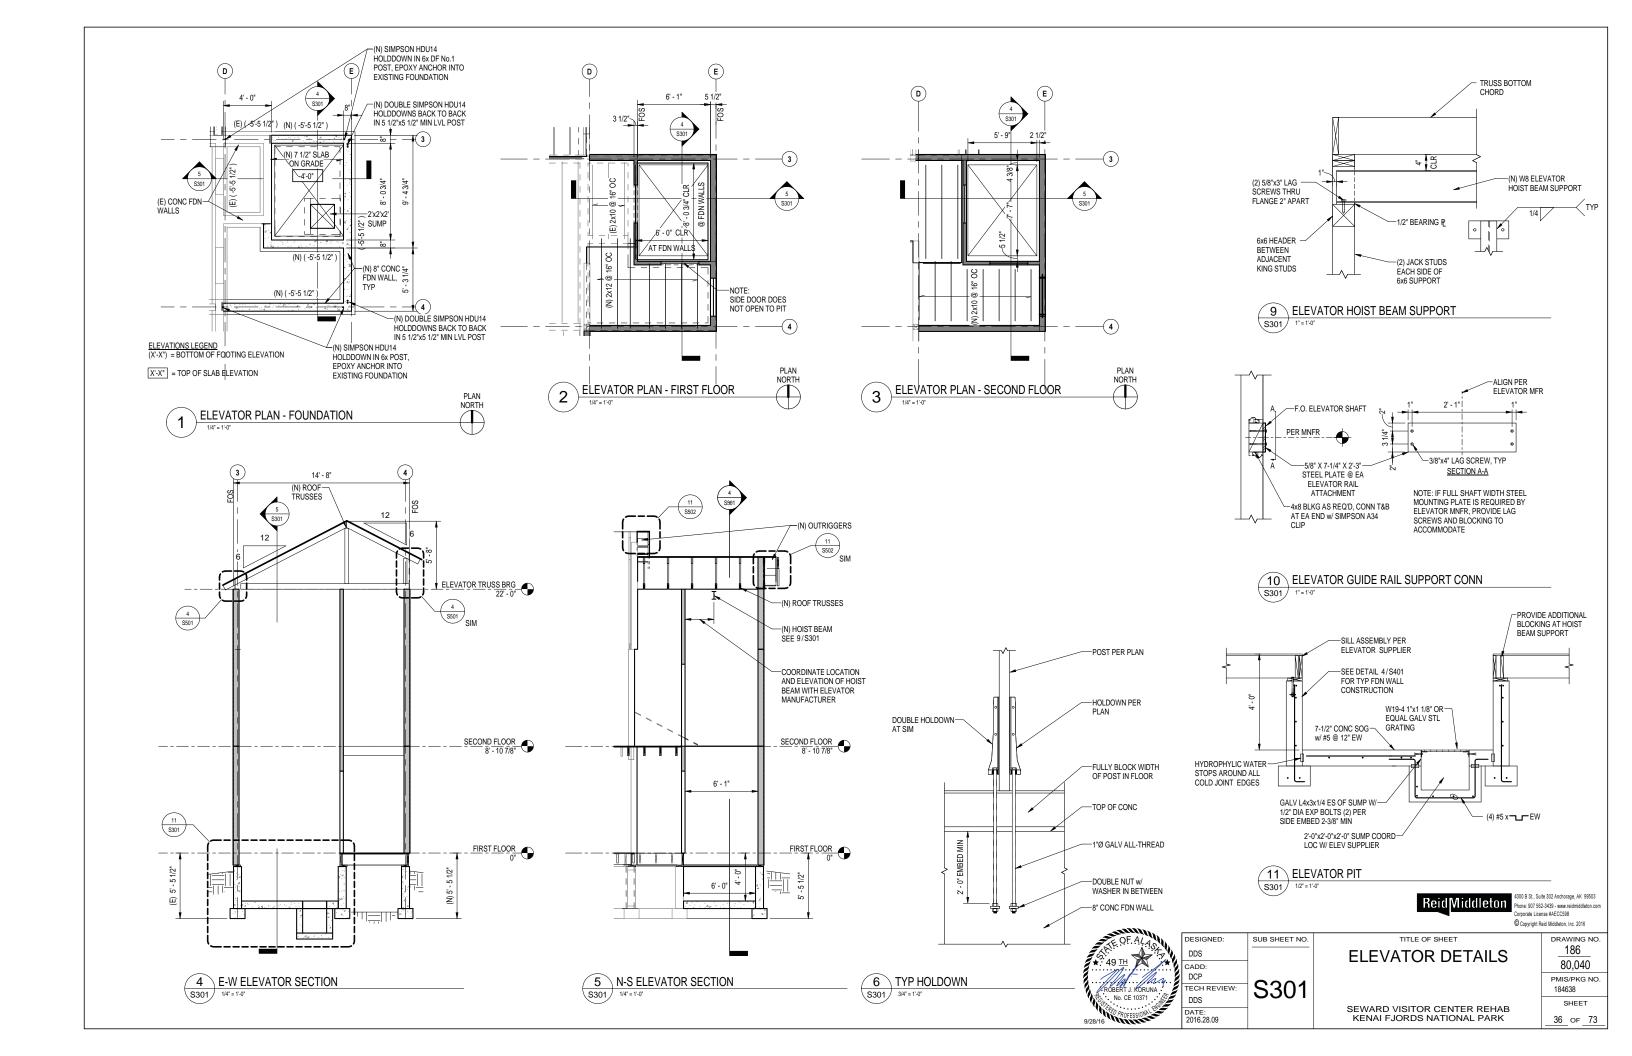
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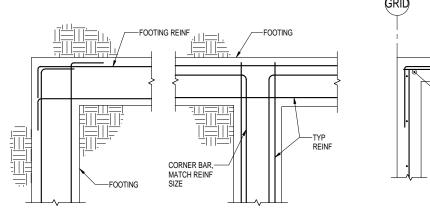
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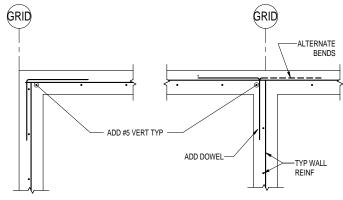
PMIS/PKG NO. 184638 SHEET 35 of 73


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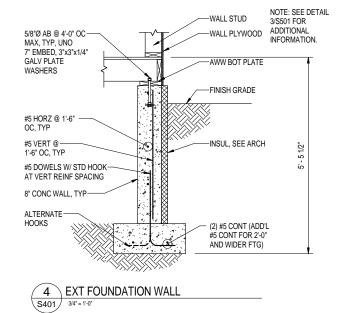
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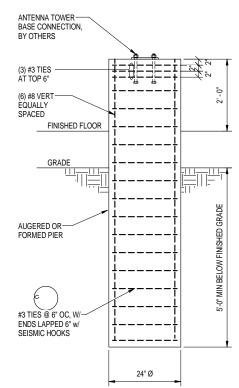
PLAN VIEW


NOTE:

1. DOWELS SHALL MATCH SIZE & SPACING OF TYP WALL REINF TIE DOWELS TO TYP WALL & FOUNDATION REINF.

3 FOUNDATION DETAIL, NEW TO EXISTING

1 300.01-TYP CONC FOOTING DETAILS

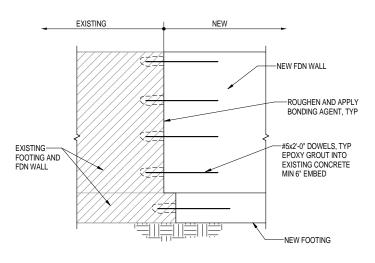

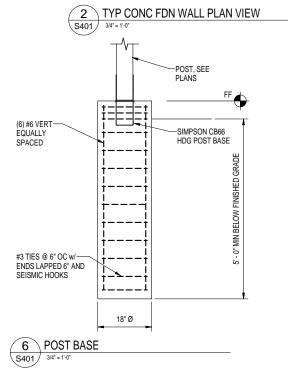

ANTENNA TOWER BASE


3/4" = 1'-0"

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DATE: 2016.28.09




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* 49 <u>1H</u>	CADD: DCP	0-01
ROBERT J. KORUNA	TECH REVIEW:	S501
No. CE 10371	DDS	0001
9/28/16	DATE: 2016.28.09	

FRAMING DETA	۱

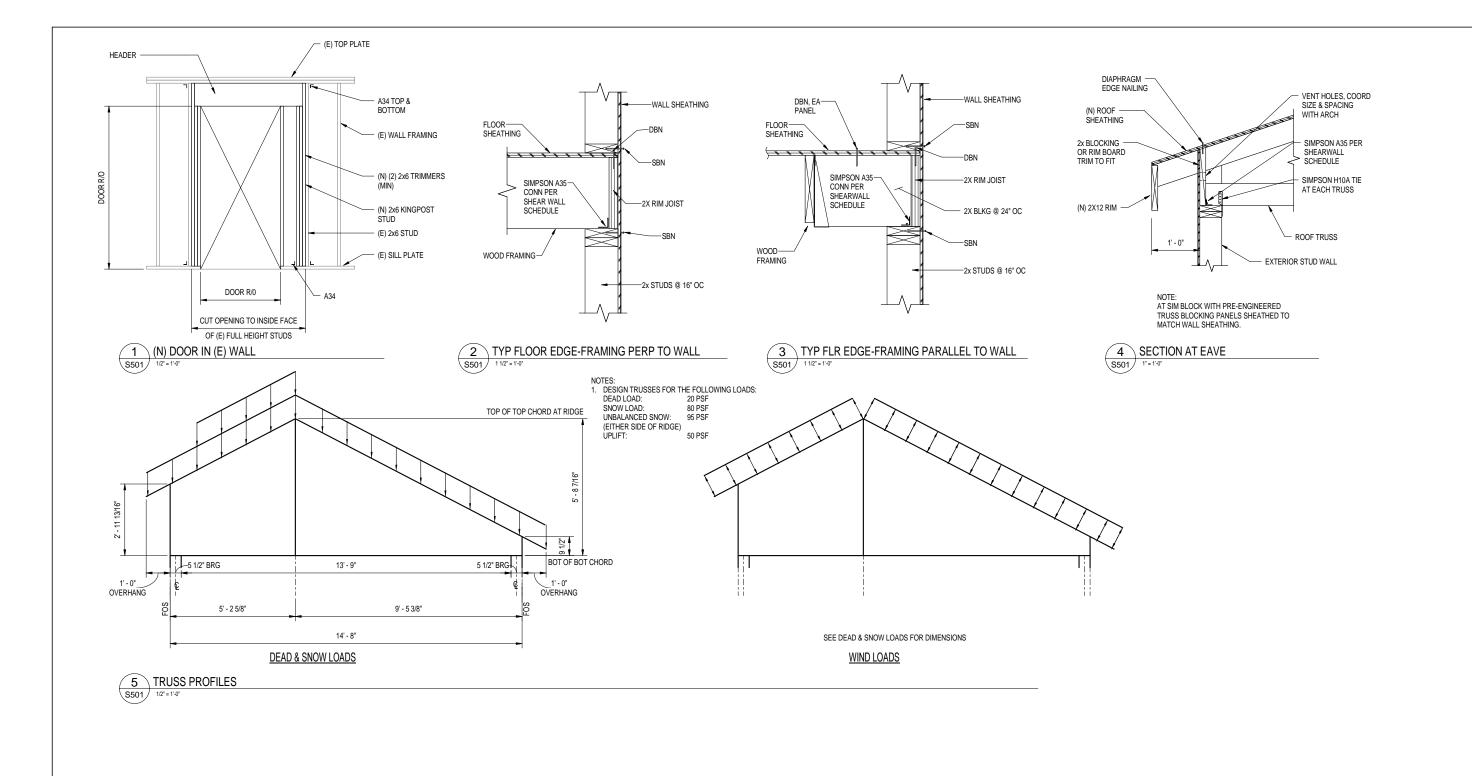drawing no. ILS 80,040 PMIS/PKG NO. 184638 SHEET SEWARD VISITOR CENTER REHAB KENAI FJORDS NATIONAL PARK 38 of 73

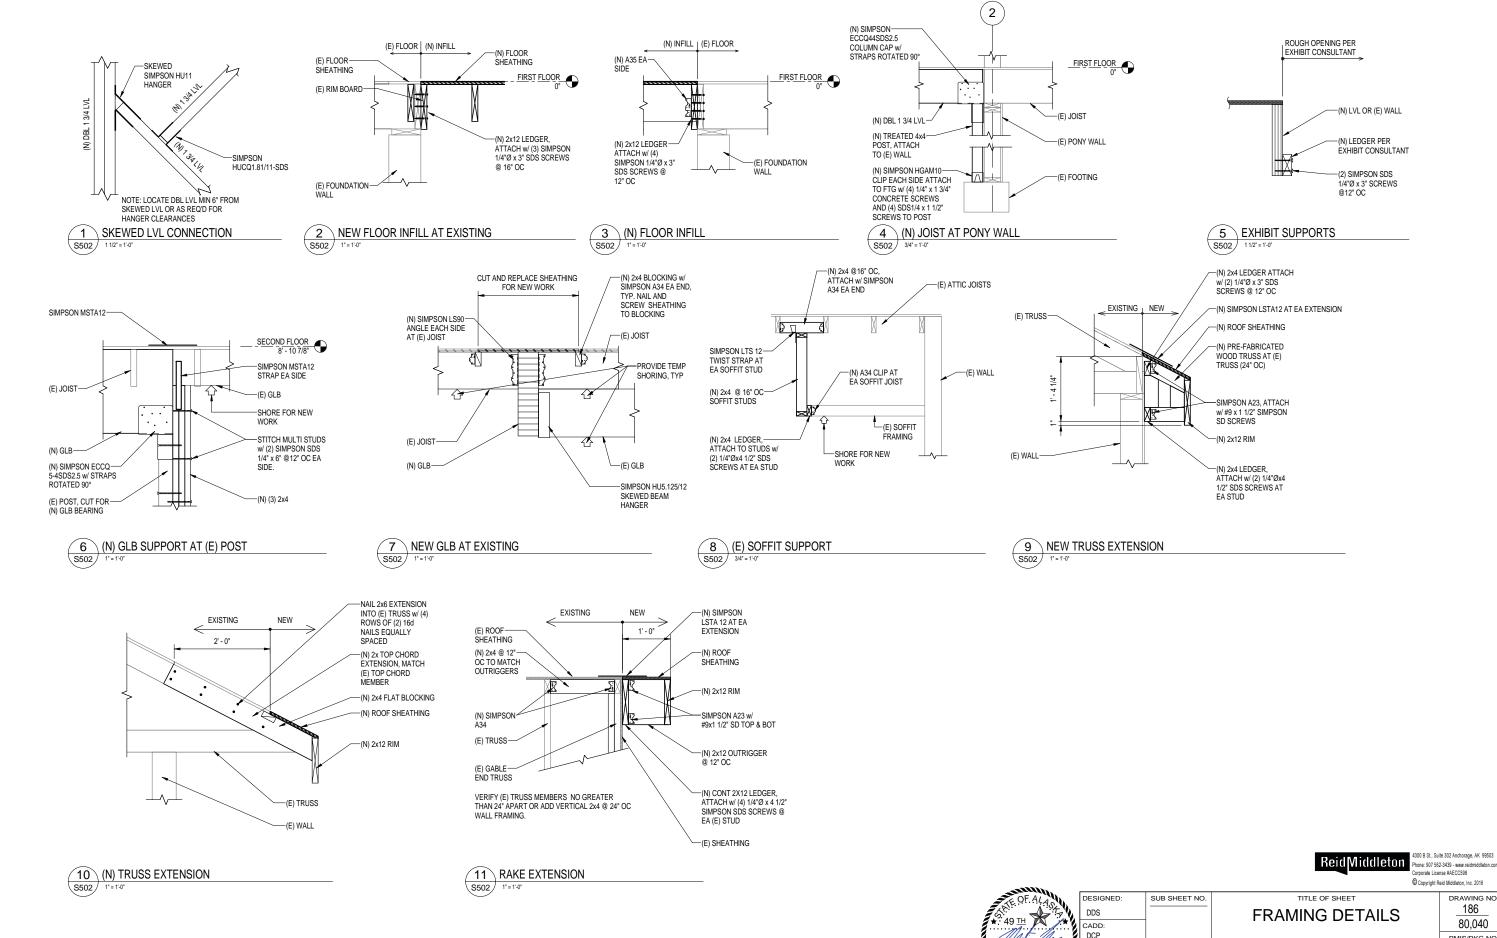

S502

TECH REVIEW

DDS

DATE: 2016.28.09

No. CE 10371

PIPING LEGEND	DUCTWORK LEGEND	ABBREVIATIONS
PIPING LEGEND	THERMOSTAT (HEATING)  THERMOSTAT WITH GUARD  SUPPLY AIR UP & DOWN  EXHAUST AIR UP & DOWN  ROUND DUCT UP & DOWN  DUCT SIZE  (FIRST FIGURE - SIDE SHOWN) (SECOND FIGURE - SIDE NOT SHOWN)	AAV AUTOMATIC AIR VENT ABV ABOVE ADA AMERICAN WITH DISABILITIES ACT GUIDELINES GUIDELINES GUIDELINES ADA ACCESS DOOR AFF ABOVE FINISHED FLOOR AFF ABOVE FINISHED GRADE AHAND AFG ABOVE FINISHED GRADE AHAND ACF ABOVE FINISHED GRADE AHAND ACF ABOVE FINISHED GRADE AHAND ACF ABOVE FINISHED GRADE AHAND AS HIGH AS POSSIBLE ALA ALUMINUM ALA ALUMINUM AMPERES AMPORERS AMPERES AMPORERS AMPORERS AMPORERS AMPORERS AMPORERS AMPORERS AMPORES
BALL VALVE  2-WAY CONTROL VALVE  CHECK VALVE  BALANCE VALVE  PRESSURE REDUCING VALVE	INSULATED DUCTWORK  SOUNDLINED DUCTWORK	BDD BACKDRAFT DAMPER BLDG BUILDING BOTOM OF DUCT BOD BOTTOM OF DUCT BTIN BRITISH THERMAL UNIT/HOUR CAP CAPACITY CAPACITY C/A COMBUSTION AIR CFM CUBIC FEET PER MINUTE TT FEET CIRC CIRCULATING TEMP TEMPERATURE MAX MAXIMUM THOUSAND BTUH TOD TOP OF DUCT TOD
PRESSURE REDUCTING VALVE  PRESSURE GAUGE  W/ ISOLATION COCK	LOGIC  DETAIL NUMBER SHEET LOCATED ON RADIATION DESIGNATOR LENGTH GPM  TAG SHEET NOTES	CLG CEILING GA GAUGE COMP. COMPRESSOR COMP. COMPRESSOR CONT CONTINUED CO CARBON MONOXIDE CO CARBON MONOXIDE CONN CONNECTION CONT. CONTINUATION CP—X CIRCULATION PUMP DESIGNATOR DESIGNATOR CU COPPER  GA GAUGE GAL GALLONS GAL GALLONS PER HOUR GALLONS PER HOUR MG GALLONS PER MINUTE N.O. NORMALLY OPEN N.O. NORMALLY OPEN NTS NOT TO SCALE W/WITH W/O WITHOUT O/A OUTSIDE AIR O/B OUTSIDE AIR O/B OUTSIDE DIMENSION PROPANE  NO NOISE CRITERIA VAC VOLT—AC VAC VAC VOLT—AC VAC

# PLUMBING FIXTURE SCHEDULE

SYMBOL	FIXTURE	MANUFACTURER	MODEL	CW	HW	WASTE	VENT	TRAP	COLOR/FINISH	TRIM/REMARKS
P-1	WATER CLOSET-ADA	AMERICAN STANDARD	MADERA-3461.001	1		3	2		WHITE	FLOOR MOUNT, AMERICAN STANDARD #5901.100 FRONT SEAT LESS COVER, PROVIDE WITH ROYAL 111-1.28 HIGH EFFICIENCY EXPOSED FLUSHOMETER, 1.28 GPM.
P-2	LAVATORY - WALL	AMERICAN STANDARD	LUCERNE-0355.012	1/2	1/2	1-1/2	1-1/4	1-1/4	WHITE	OPEN FAUCET HOLES ON 4" CENTERS, 0.5 GPM MODEL BY MOEN FAUCET 8413F05, PROVIDE ASSE 1070 POINT OF USE THERMOSTATIC MIXING VALVE.
P-3	DRINKING FOUNTAIN	ELKAY	EZD	1/2		1-1/2	1-1/4	1-1/4	STAINLESS	PROVIDE WITH WALL PLATE MOUNTING HARDWARE.
P-4(E)	DRINKING FOUNTAIN	ELKAY	EZWSRNF	1/2		1-1/2	1-1/4	1-1/4	STAINLESS	EXISTING DRINKING FOUNTAIN W/ BOTTLE FILL STATION, PROVIDE WALL PLATE MOUNTING HARDWARE, INSTALL AT ADA HEIGHT.
<b>-</b> 5	SINK - JANITOR	FIAT	MSB-2424	1/2	1/2	3	2	3	WHITE	FIAT FAUCET 830-AA, 832 HOSE AND BRACKET, E-77-AA VINYL BUMPERGUARD, 889-CC MOP HANGER.
9-6	LAVATORY - COUNTER	AMERICAN STANDARD	RONDALYN-0491.019	1/2	1/2	1-1/2	1-1/4	1-1/4	WHITE	OPEN FAUCET HOLES ON 4" CENTERS, 0.5 GPM MODEL BY MOEN FAUCET 8413F05, PROVIDE ASSE 1070 POINT OF USE THERMOSTATIC MIXING VALVE.
FD-1	FLOOR DRAIN	ZURN	Z-415B			2	1-1/2	2		ROUND TOP, NICKEL BRONZE STRAINER, TRAP PRIMER CONNECTION.

## BOILER SCHEDULE

				ELECT	RICAL							
SYM	MBOL	MANUFACTURER	MODEL	MEDIUM	FUEL	GPH	мвн	CAPACITY (GAL.)	1ST HOUR RATING (77° F RISE)	AMPS	VOLT/PH	REMARKS
В-	1	ENERGY KINETICS	EK-2, SYSTEM 2000	WATER	#2 FUEL OIL	1.2	147	40	293 GAL/HR.	7.5	120/1	PROVIDE AS "FRONTIER STACKABLE" SYSTEM WITH THE FOLLOWING EQUIPMENT: CONCENTRIC POWER VENT KIT FOR BOILER COMBUSTION AIR INTAKE AND EXHAUST, CARLIN 99FRD BURNER, BURNER COMBUSTION AIR BOX KIT, LOW WATER CUT OUT, REDUNDANT HIGH LIMIT, INTEGRAL STAND FOR STACKABLE BOILER/WATER HEATER, 40 GAL. WATER HEATER, BOILER PUMP CP-1, DOMESTIC WATER HEATING PUMP CP-4, DOMESTIC WATER HEAT EXCHANGER HX-1.

## PUMP SCHEDULE

				PUMPED		HEAD	ELECTRI	RICAL						
SYMBOL	MANUFACTURER	MODEL	FUNCTION	MEDIUM	GPM	FEET	HP	VOLTS/PH	REMARKS					
CP-1	TACO	0010	BOILER CIRCULATION	HTG WATER	15	10	1/8	120/1	CAST IRON CONSTRUCTION, IN-LINE PUMP.					
CP-2	TACO	2445	SYSTEM CIRCULATION	HTG WATER	15	30	1/3	120/1	CAST IRON CONSTRUCTION, IN-LINE PUMP.					
CP-3	TACO	003-PNP	HOT WATER RECIRCULATION	WATER	0.5	4	1/40	120/1	PROVIDE WITH CHECK VALVE, 24-HOUR TIMER AND AQUASTAT, NSF-61 LISTED FOR USE WITH POTABLE WATER.					
CP-4	TACO	0060	DOMESTIC HOT WATER	WATER	4.25	5	1/40	120/1	PROVIDE WITH CHECK VALVE, BRONZE CONSTRUCTION, NSF-61 LISTED FOR USE WITH POTABLE WATER.					
SP-1	ZOELLER	M137	SUMP DISCHARGE	WATER	50	17	1/2	120/1	AUTOMATIC OPERATION, ALL CAST IRON PUMP, 1-1/2" DISCHARGE, INTEGRAL FLOAT AND SWITCH, 3-PRONG CORD AT 9 FT. LONG.					

## EXPANSION TANK SCHEDULE

						TANK VOLUME	•			
SYMBOL	MANUFACTURER	MODEL	FUNCTION	MEDIUM	MATERIAL	TOTAL (GAL)	ACCEPTANCE (GAL)	DIMENSIONS	REMARKS	
ET-1	AMTROL	SX-30V	HEATING	WATER	STEEL/BUTYL	14	11.3	24" H X 15" DIA	PRECHARGE TO 12 PSI.	
ET-2	THERM-X-TROL	ST-12	HEATING	WATER	STEEL/BUTYL	14	11.3	24" H X 15" DIA	PRECHARGE TO 12 PSI.	

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Compared No. - AFC/CEG.



THEE OF STREET
LEGEND,
ABBREVIATIONS &
SCHEDULES

SEWARD VISITOR CENTER REHAB KENAI FJORDS NATIONAL PARK 186 80,040 PMIS/PKG NO. 184638

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#### AIR SEPARATOR SCHEDULE

SYMBOL	MANUFACTURER	MODEL	SIZE	CONNECTION	MATERIAL	FLUID	REMARKS
AS-1	SPIROTHERM	VDR 150	1-1/2"	THREADED	STEEL	WATER	COMBINATION AIR AND DIRT SEPARATOR, MANUAL DIRT DRAIN VALVE, AUTOMATIC AIR VENT.

#### HEAT EXCHANGER SCHEDULE

					HOT SIDE					COLD SIDE					
						FLOW	WPD	EWT	LWT		FLOW	WPD	EWT	LWT	
SYMBOL	MANUFACTURER	MODEL	TYPE	FUNCTION	MEDIUM	(GPM)	(FT HD)	DEG F	DEG F	MEDIUM	(GPM)	(FT HD	) DEG F	DEG F	REMARKS
HX-1	ENERGY KINETICS	#18 PHE	BRAZED PLATE	DOMESTIC HOT WATER	WATER	12.0	9.0	180	140	WATER	4.0	1.0	40	140	DOUBLE WALL FOR USE WITH DOMESTIC WATER, MOUNTING BRACKET.

#### UNIT HEATER SCHEDULE

			CAPACITY			EWT	LWT	WPD			ELECTRI	CAL	
SYMBOL	MANUFACTURER	MODEL	MBH	MEDIUM	GPM	DEG F	DEG F	FT HD	CFM	RPM	HP	VOLTS/PH	REMARKS
UH-1	MODINE	MODINE HSB-24	12.6	WATER	1.5	180	160	0.6	370	1550	1/25	120/1	HORIZONTAL THROW UNIT HEATER, PROVIDE WITH WALL MOUNTED LOCAL THERMOSTAT.

#### HEAT RECOVERY VENTILATOR SCHEDULE

						ESP	ELECT	RICAL		
SYMBOL	MANUFACTURER	MODEL	AREA SERVED	COIL TAG	CFM	IN. W.C.	AMPS	WATTS	VOTLS/PH WEIGHT	REMARKS
HRV-1	AMERICAN ALDES	H650-FI	THEATER	HC-1	500	0.6	5.5	660		SUPPLY AND EXHAUST FANS, DIRECT DRIVE, MULTIPLE SPEED SETTINGS, (4) MERV 8 FILTERS, 24 VAC OUTPUT FOR SUPPLY AND EXHAUST DAMPERS, OCCUPANCY AND SPEED CONTROL, INDEPENDENT SUPPLY AND EXHAUST FAN

#### HEATING COIL SCHEDULE

					APD P.D.	FACE VEL.	EAT	LAT			EWT	LWT	WPD	
SYMBOL	MANUFACTURER	MODEL	OUTPUT MBH	CFM	IN. W.C.	FPM	DEG F	DEG F	GP <b>M</b>	MEDIUM	DEG F	DEG F	FT HD	REMARKS
HC-1	LUVATA	5BS0601A 15 X 12	16.3	500	0.02	300	40	70	1.6	WATER	180	160	0.86	DUCT MOUNTED HEATING COIL. SEE PLAN FOR LOCATION.

#### FINNED TUBE SCHEDULE

SYMBOL	MANUFACTURER	MODEL	MEDIUM	EWT	LWT	ELEMENT	BTUH/ LIN. FT	REMARKS
FT-1	STERLING	JVB-S	WATER	180	160	4-1/4" x 3-5/8"	1120	3/4" DIA. COPPER TUBE, 50 FINS PER FOOT, 14" ENCLOSURE HEIGHT AT 18 GAUGE, STYLE 'S' ENCLOSURE WITH END CAPS AND MOUNTING HARDWARE.
FT-2	STERLING	JVB-E	WATER	180	160	4-1/4" x 3-5/8"	775	3/4" DIA. COPPER TUBE, 50 FINS PER FOOT, 6" ENCLOSURE HEIGHT AT 18 GAUGE, STYLE 'E' ENCLOSURE WITH END CAPS AND MOUNTING HARDWARE.
FT-3	STERLING	JVB-S	WATER	180	160	4-1/4" x 3-5/8"	1120	SAME FINTUBE ELEMENT AS FT-1 LESS ENCLOSURE FOR INSTALLATION BEHIND CASEWORK OR IN EXISTING ENCLOSURES AS SHOWN ON PLANS, PERFORMANCE BASED ON 14" ENCLOSURE HEIGHT, 3/4" DIA. COPPER TUBE, 50 FINS PER FOOT.

#### AIR INLET/OUTLET SCHEDULE

,	, 0	· · ·	OO							
SYMBOL	MANUFACTURER	MODEL	TYPE	USE	MATERIAL	FINISH	CFM	FACE SIZE (IN.)	NC	REMARKS
A	TITUS	50F	CEILING	R/A	ALUMINUM	WHITE	PER PLANS	PER PLANS	12	1/2" X 1/2" X 1/2" EGGCRATE CORE, SURFACE MOUNT FRAME W/ COUNTER SUNK SCREW HOLES.

### FAN SCHEDULE

						ESP		MOTOR [	DATA			
SYMBOL	MANUFACTURER	MODEL	TYPE	SERVICE	CFM	IN W.C.	RPM	WATTS	POWER	DRIVE	SONES	REMARKS
EF-1,2	PANASONIC	FV-11VQ5	CEILING	RESTROOM-1ST FLOOR	91	0.25	1161	20.7	120/1	DIRECT	0.5	SWITCH WITH LIGHTS, BACK DRAFT DAMPER AND WALL CAP.
EF-3	PANASONIC	FV-11VQ5	CEILING	RESTROOM-2ND FLOOR	91	0.25	1161	20.7	120/1	DIRECT	0.5	SWITCH WITH LIGHTS, BACKDRAFT DAMPER AND WALL CAP.
EF-4	PANASONIC	FV-08VQ5	CEILING	JANITOR	62	0.25	1089	14.5	120/1	DIRECT	0.4	SWITCH WITH LIGHTS, BACK DRAFT DAMPER AND WALL CAP.
VF-1	СООК	GN-182	INLINE	MECHANICAL	200	0.25	1297	162	120/1	DIRECT	4.5	INLINE FAN, SUPPORT FAN FROM STRUCTURE, PROVIDE WITH FAN SPEED CONTROLLER.




TITLE OF SHEET SCHEDULES

80,040 PMIS/PKG NO. 184638

SEWARD VISITOR CENTER REHAB KENAI FJORDS NATIONAL PARK

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1. DEMOLISH ALL PIPING IN CRAWLSPACE.

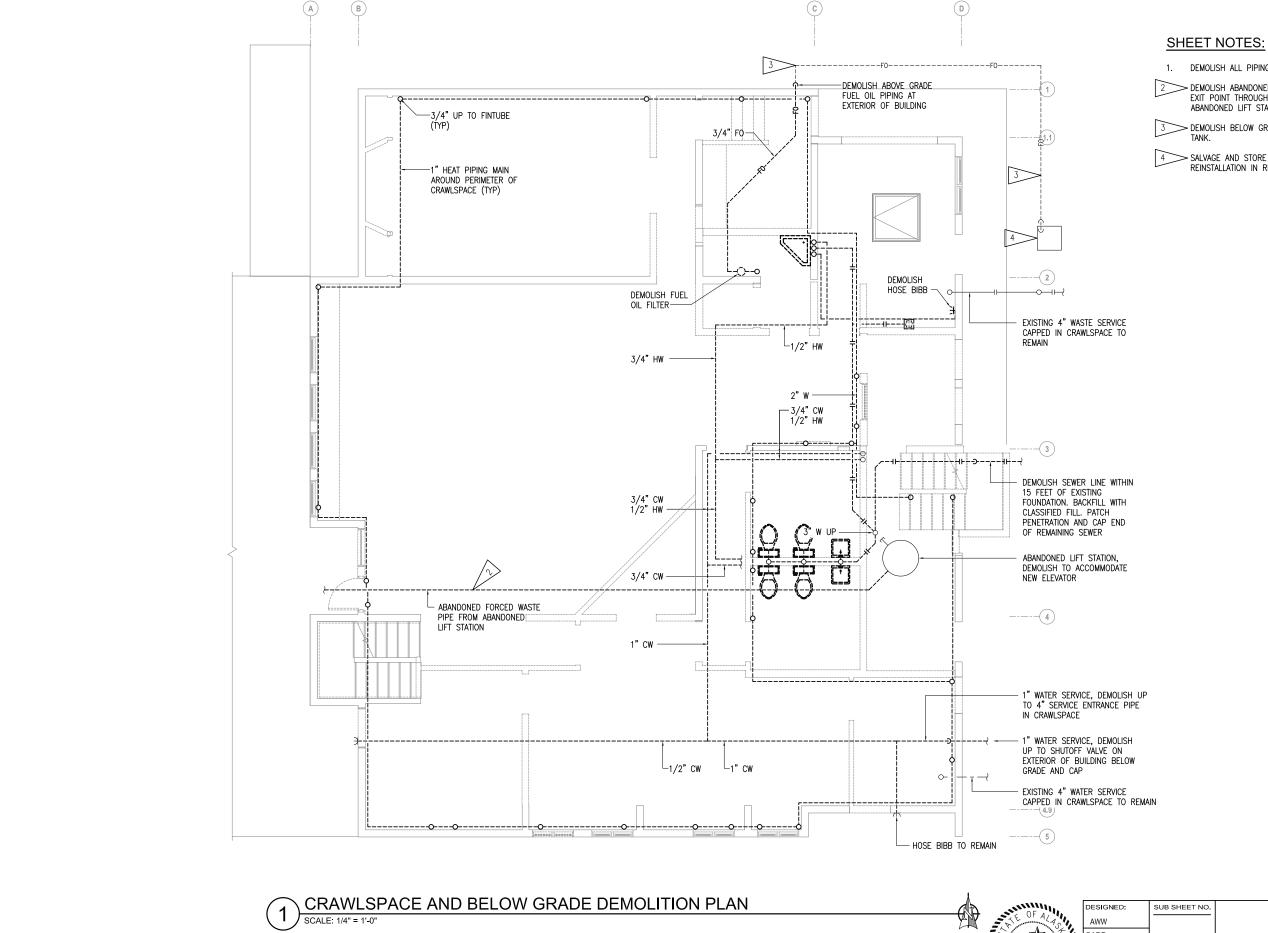DEMOLISH ABANDONED FORCED MAIN PIPE FROM ABANDONED LIFT STATION TO EXIT POINT THROUGH CRAWLSPACE WALL. CAP PIPE AT CRAWLSPACE WALL AND ABANDONED LIFT STATION.

3 DEMOLISH BELOW GRADE FUEL OIL PIPING FROM BUILDING TO FUEL OIL STORAGE

SALVAGE AND STORE ABOVE GRADE 500 GALLON FUEL OIL STORAGE TANK FOR REINSTALLATION IN REMODEL.




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**CRAWLSPACE DEMOLITION PLAN** 

SEWARD VISITOR CENTER REHAB KENAI FJORDS NATIONAL PARK

DRAWING NO. 80.040 PMIS/PKG NO. 184638

SHEET 42 of <u>73</u>

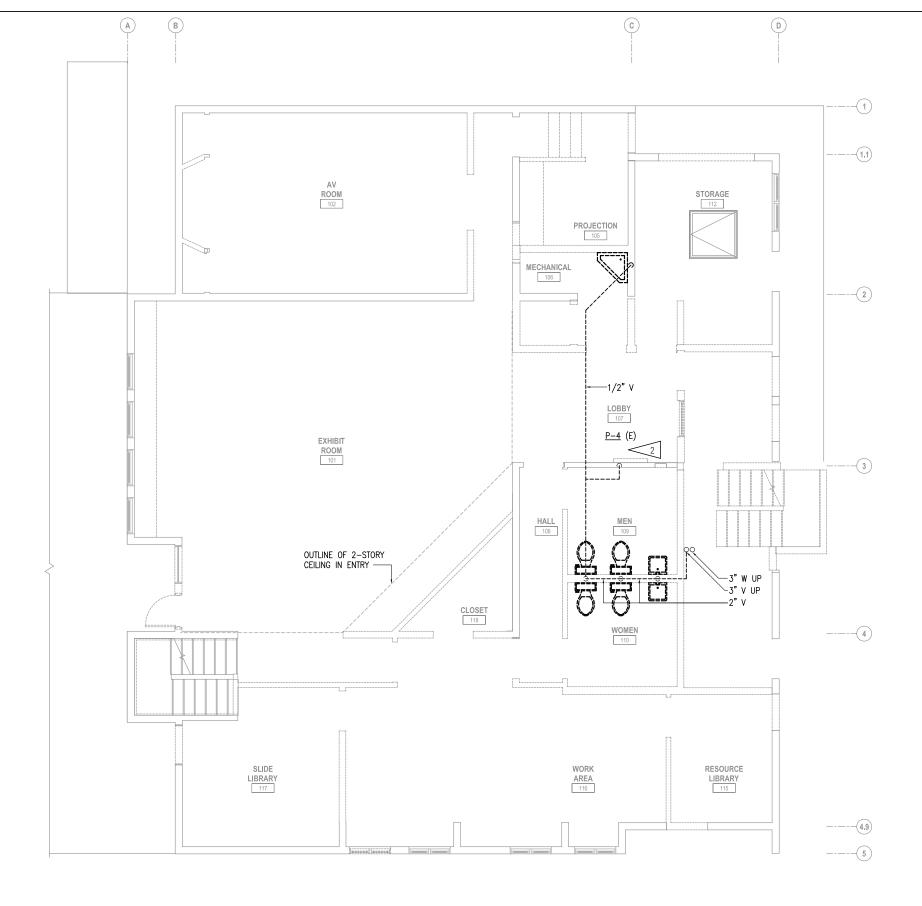

1. DEMOLISH ALL PLUMBING FIXTURES AND DOMESTIC WATER PIPING THROUGHOUT FIRST FLOOR, UNLESS OTHERWISE NOTED.

2 SALVAGE AND STORE DRINKING FOUNTAIN AND BOTTLE FILL STATION FOR REINSTALLATION IN REMODEL. DEMOLISH ALL ASSOCIATED PIPING.

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Corporate No. AECC542 RSA Jobel RSA Jobel RSA Jobel RSA

FIRST FLOOR PLUMBING DEMOLITION PLAN

SCALE: 1/4" = 1'-0"




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FIRST FLOOR PLUMBING
DEMOLITION PLAN

SEWARD VISITOR CENTER REHAB KENAI FJORDS NATIONAL PARK 186 80,040 PMIS/PKG NO. 184638 SHEET

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1. DEMOLISHING ALL PLUMBING FIXTURES AND DOMESTIC WATER PIPING THROUGHOUT SECOND FLOOR, UNLESS OTHERWISE NOTED.

CONFERENCE 210 COUNTER MOUNTED SINK SHALL REMAIN. DEMOLISH ALL ASSOCIATED PIPING.
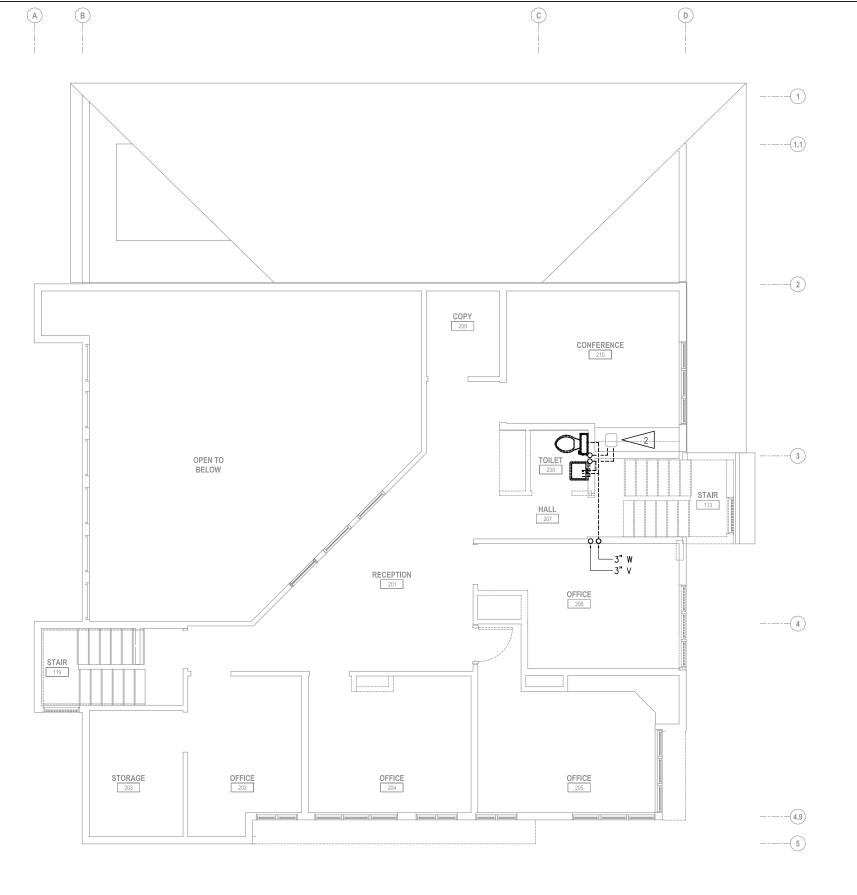
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SECOND FLOOR PLUMBING DEMOLITION PLAN

SCALE: 1/4" = 1'-0"



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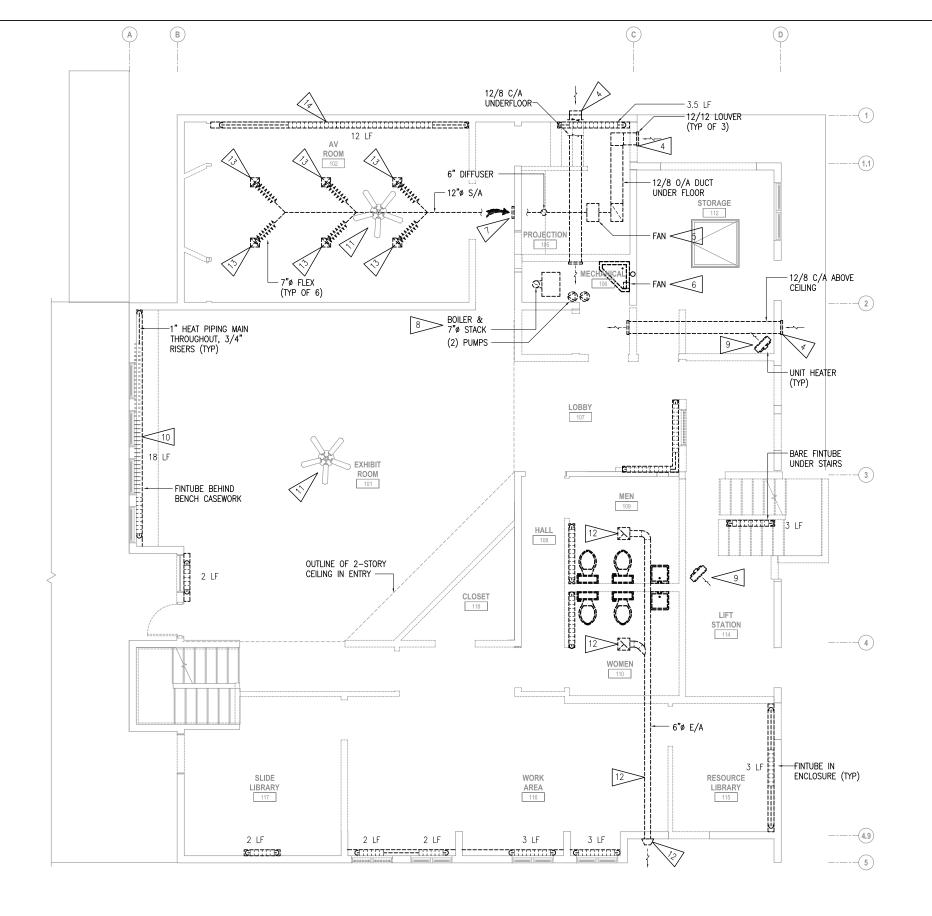
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SECOND FLOOR
PLUMBING DEMOLITION
PLAN

SEWARD VISITOR CENTER REHAB KENAI FJORDS NATIONAL PARK DRAWING NO. 186 80,040

PMIS/PKG NO. 184638

SHEET

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- DEMOLISH ALL HEATING EQUIPMENT INCLUDING BASEBOARD FINTUBE AND ENCLOSURES, PIPING, SELF CONTAINED THERMOSTATIC ZONE VALVE (TYP OF APPROX. 13), HANGERS AND ALL ASSOCIATED EQUIPMENT.
- 2. HEATING PIPING FOR FIRST FLOOR IS INSTALLED IN CRAWLSPACE, SEE M101.
- DEMOLISH ALL DUCTWORK INCLUDING S/A IN ATTIC ABOVE THEATER, O/A AND R/A AND C/A UNDER PROJECTION ROOM FLOOR, AND C/A ABOVE STORAGE ROOM. DEMOLISH ALL S/A DIFFUSERS (TYP OF 7).
- demolish Louver on exterior of building and patch opening. Coordinate with architectural, Typ of 3.
- DEMOLISH VENTILATION FAN IN PROJECTION ROOM AND ALL ASSOCIATED CONTROLS AND APPURTENANCES.
- 6 DEMOLISH VENTILATION FAN IN MECHANICAL 106 AND ALL ASSOCIATED CONTROLS AND APPURTENANCES.
- DEMOLISH R/A GRILLE AT BACK WALL OF THEATER.
  - DEMOLISH BOILER PLANT INCLUDING BOILER, BOILER VENT, (2) CIRCULATION PUMPS, CONTROLS, PIPING AND APPURTENANCES.
- DEMOLISH UNIT HEATER AND ALL ASSOCIATED CONTROLS AND APPURTENANCES (TYP OF 2).
- 10 DEMOLISH FINTUBE BEHIND BENCH AND BENCHTOP GRILLES.
- 11 DEMOLISH CEILING FAN IN AV ROOM 102 AND EXHIBIT ROOM 101.
- DEMOLISH BATHROOM EXHAUST FANS AND ASSOCIATED DUCTWORK AND EXTERIOR WALL CAP. DUCTWORK SIZE AND LOCATION IS ASSUMED BASED ON EXISTING CONDITIONS. CONTRACTOR TO VERIFY.
- REMOVE 9/9 DIFFUSER IN THEATER CEILING AND STORE FOR REINSTALLATION IN REMODEL (TYP OF 6).
- IN THEATER DEMOLISH HEATING FINTUBE, PIPING, SELF-CONTAINED THERMOSTATIC ZONE VALVE, HANGER AND ALL ASSOCIATED EQUIPMENT. ALL ENCLOSURES SHALL BE SALVAGED FOR REUSE IN REMODEL.

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1 FIRST FLOOR HVAC DEMOLITION PLAN



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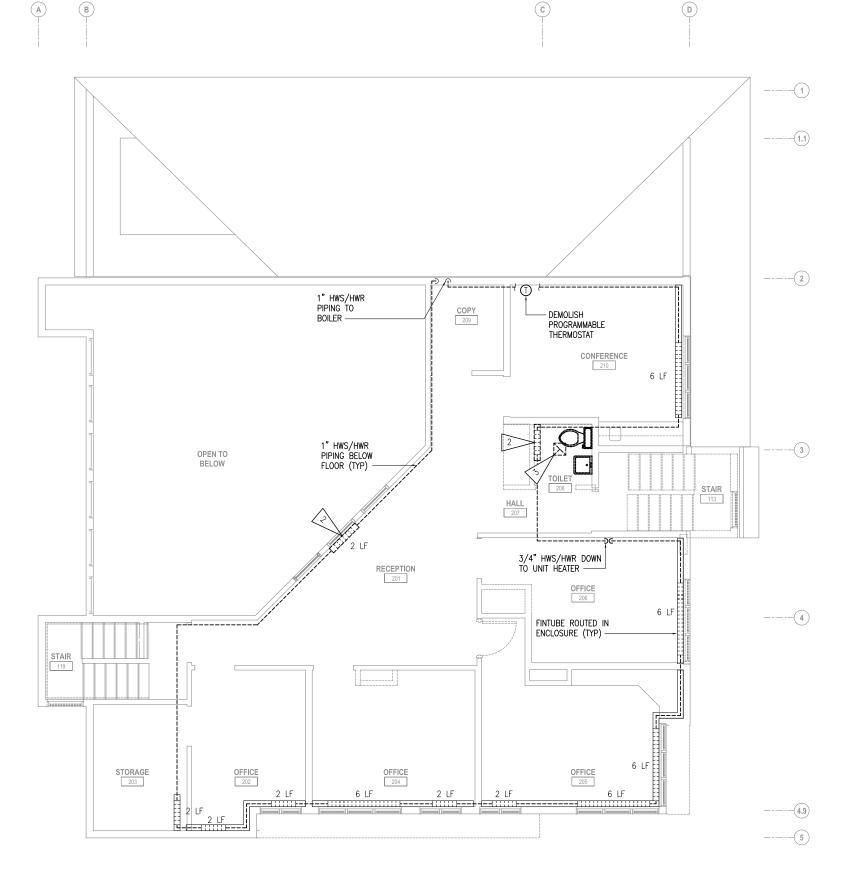
FIRST FLOOR HVAC DEMOLITION PLAN

TITLE OF SHEET

SEWARD VISITOR CENTER REHAB KENAI FJORDS NATIONAL PARK

DRAWING NO.

SHEET 45 OF 73



 DEMOLISH ALL HEATING FINTUBE, PIPING, SELF CONTAINED THERMOSTATIC ZONE VALVE (TYP OF APPROX. 13), HANGERS AND ALL ASSOCIATED EQUIPMENT. ALL ENCLOSURES SHALL BE SALVAGED FOR REUSE IN REMODEL UNLESS OTHERWISE NOTED.

DEMOLISH FINTUBE ENCLOSURE.

DEMOLISH CEILING MOUNTED EXHAUST FAN/LIGHT AND ASSOCIATED DUCTWORK.
DUCTWORK IS ASSUMED TO TERMINATE IN ATTIC BASED ON EXISTING
CONDITIONS. CONTRACTOR TO VERIFY.

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SECOND FLOOR HVAC DEMOLITION PLAN

SCALE: 1/4" = 1'-0"



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DEMOLITION PLAN


SEWARD VISITOR CENTER REHAB KENAI FJORDS NATIONAL PARK DRAWING NO.

186

80,040

PMIS/PKG NO.
184638

SHEET 46 OF 73

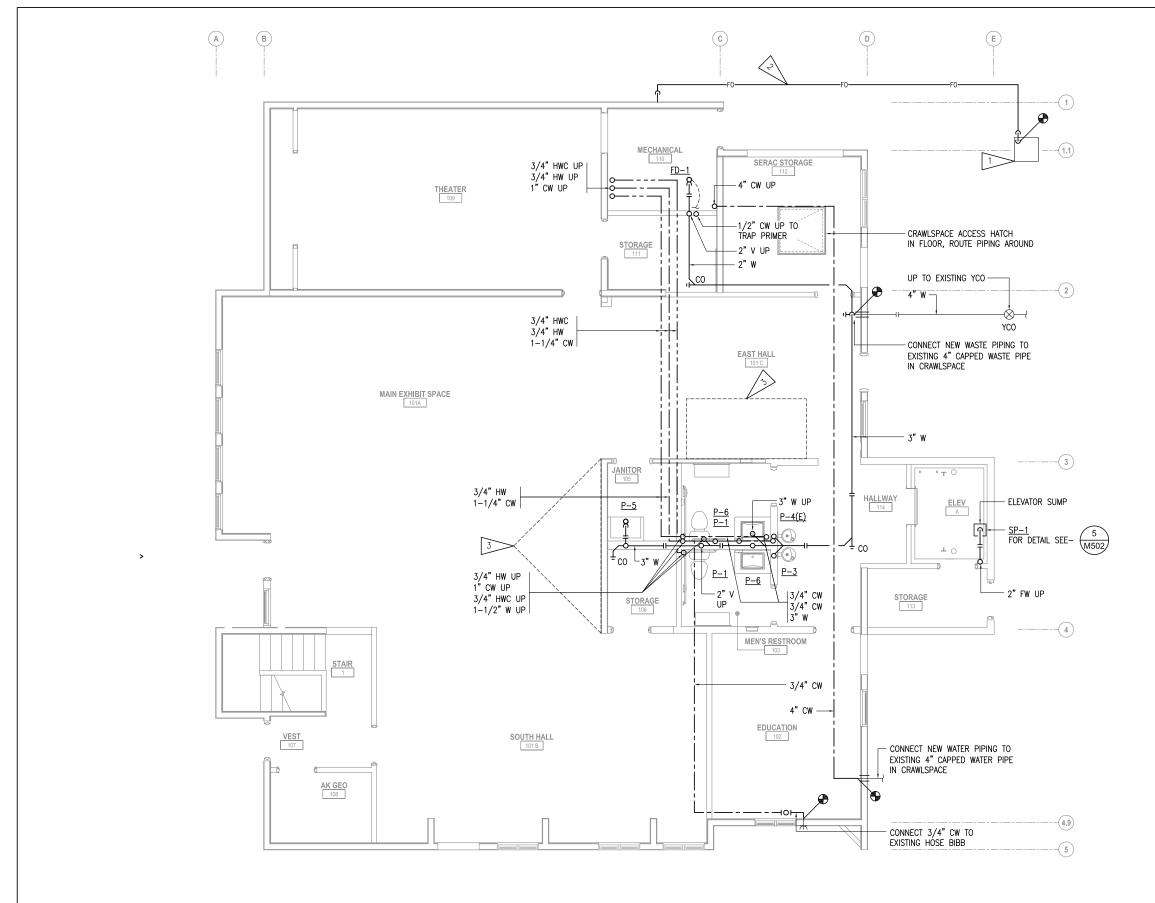

REINSTALL SALVAGED FUEL OIL STORAGE TANK. COORDINATE EXACT LOCATION WITH SITE PLAN. FOR DETAIL SEE - 8

INSTALL NEW DOUBLE CONTAINMENT PIPE BELOW GRADE FOR FUEL OIL TRANSFER BETWEEN THE FUEL OIL STORAGE TANK AND BUILDING. FOR PIPE TERMINATION DETAILS AT BUILDING AND FUEL OIL STORAGE TANK SEE —

>THIS AREA RESERVED FOR FLOOR-RECESSED MUSEUM DISPLAY. DO NOT ROUTE PIPING IN THIS AREA. SEE ARCHITECTURAL AND STRUCTURAL FOR EXACT LOCATIONS.

CRAWLSPACE AND BELOW GRADE PLUMBING REMODEL PLAN




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TITLE OF SHEET FIRST FLOOR UNDER FLOOR PLUMBING REMODEL PLAN

SEWARD VISITOR CENTER REHAB KENAI FJORDS NATIONAL PARK 47 of 73

80,040 PMIS/PKG NO. 184638 SHEET

DRAWING NO.

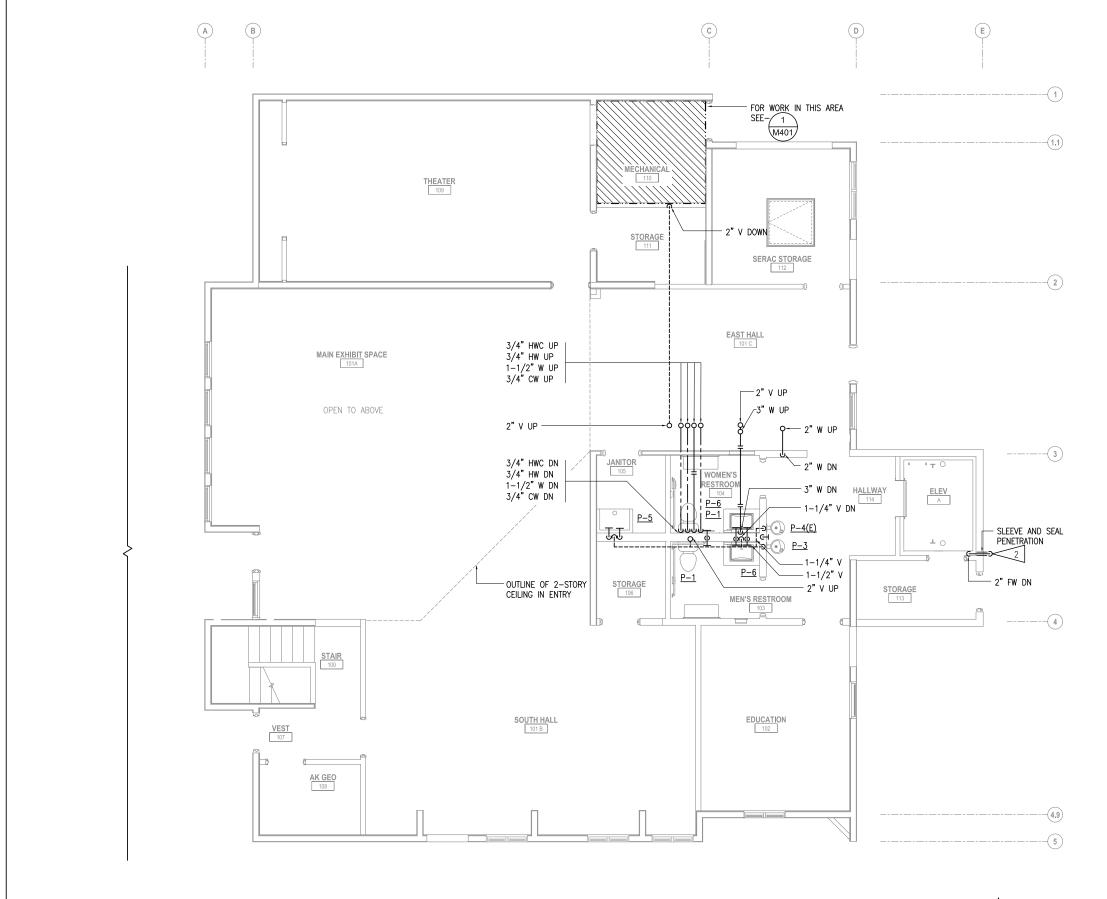

1. ROUTE PIPING IN CEILING BETWEEN EXISTING JOISTS. SEE STRUCTURAL.

ELEVATOR PIT DISCHARGE OUTLET 36" ABOVE GRADE. INSTALL BRONZE OUTLET SPOUT ON WALL AT TERMINATION. INSTALL PLACARD ABOVE OUTLET THAT READS, "ELEVATOR SUMP PUMP DISCHARGE."

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FIRST FLOOR PLUMBING REMODEL PLAN

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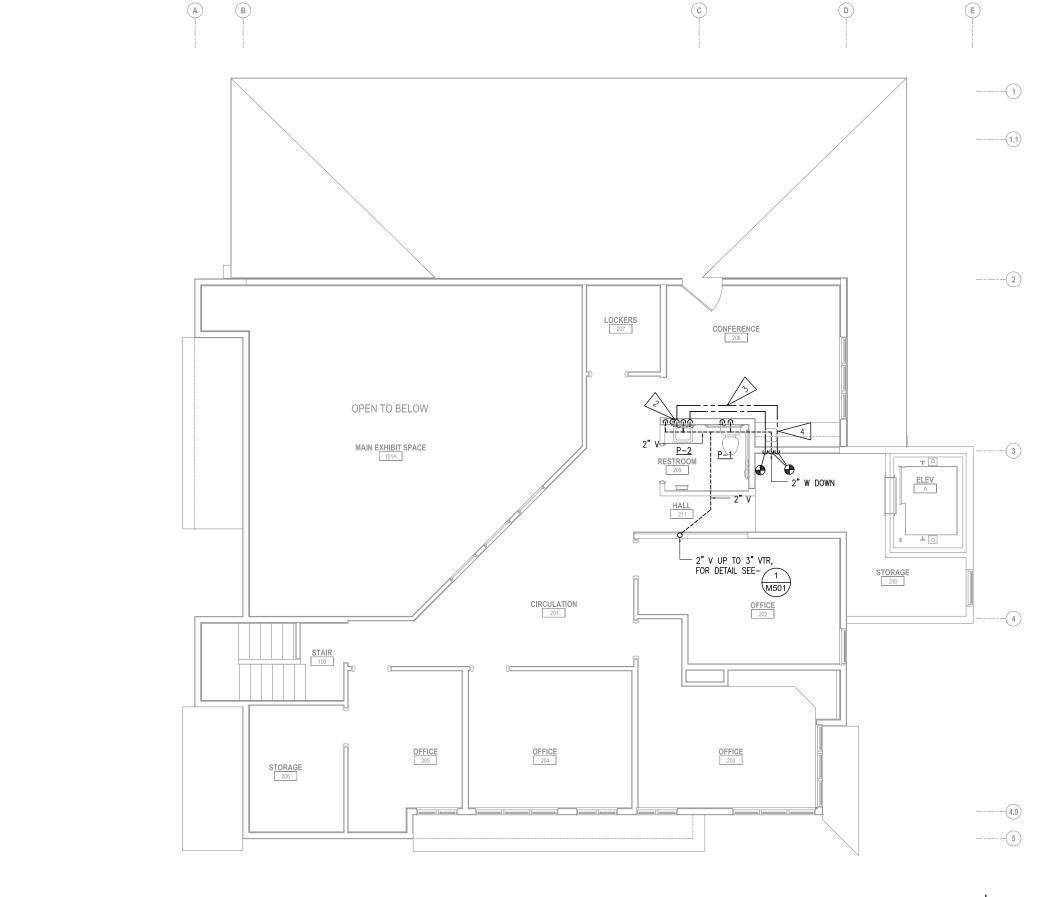


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FIRST FLOOR ABOVE FLOOR PLUMBING REMODEL PLAN

SEWARD VISITOR CENTER REHAB KENAI FJORDS NATIONAL PARK 186 80,040 PMIS/PKG NO. 184638 SHEET

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ROUTE HORIZONTAL RUNS OF VENT PIPING IN ATTIC.

2 CONNECT HOT WATER RECIRCULATION PIPE TO LAVATORY HOT WATER

ROUTE CW/HW PIPING IN WALL TO EXISTING SINK, SHOWN OFFSET FOR CLARITY.

CONNECT NEW 1/2" CW, 1/2" HW, 2" W AND 1-1/4" V TO EXISTING SINK IN CONFERENCE 208. PROVIDE ANGLE STOPS AT WALL FOR WATER PIPING. INSTALL A POINT OF USE ASSE 1070 THERMOSTATIC MIXING VALVE ON THE HOT WATER SUPPLY TO THE SINK. WATTS MODEL LFMMV OR APPROVED EQUAL.

SECOND FLOOR PLUMBING REMODEL PLAN




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TITLE OF SHEET SECOND FLOOR ABOVE FLOOR PLUMBING REMODEL PLAN

PMIS/PKG NO. 184638 SEWARD VISITOR CENTER REHAB KENAI FJORDS NATIONAL PARK

SHEET 49 of <u>73</u>

DRAWING NO.

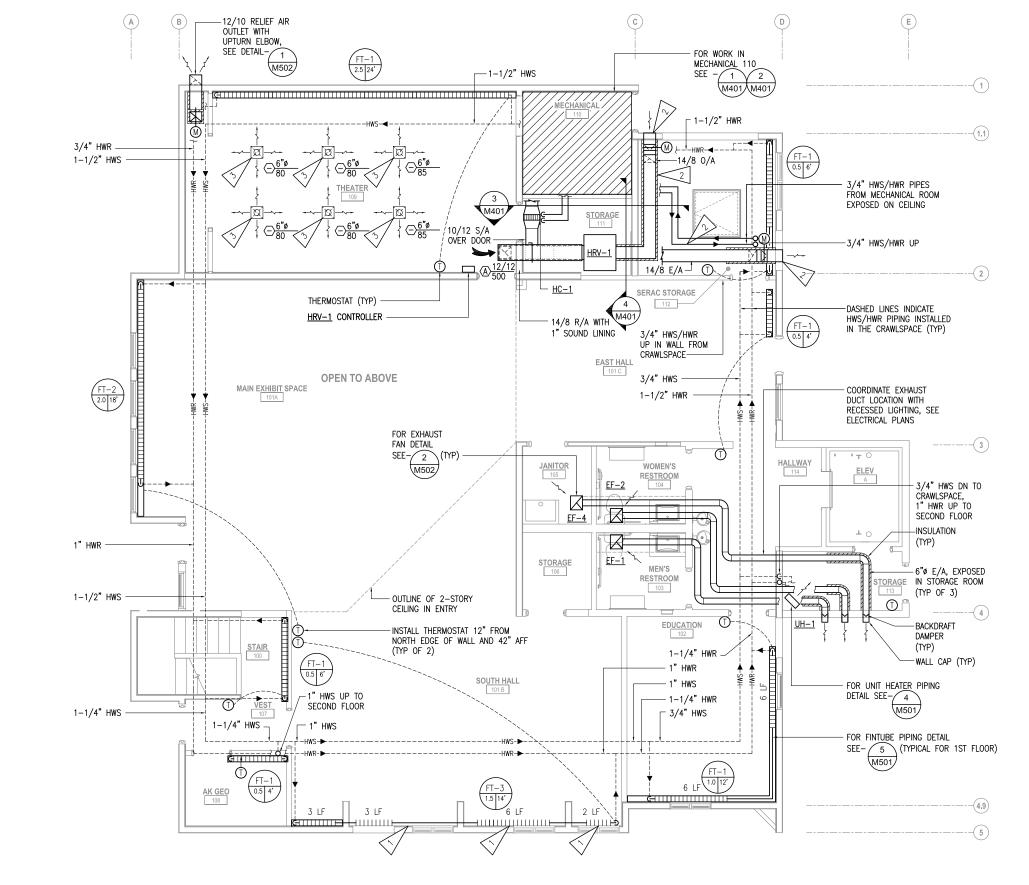

INSTALL BARE FINTUBE BEHIND CASEWORK. GRILLE IN CASEWORK COUNTER TOP TO BE PROVIDED AND INSTALLED BY EXHIBIT FABRICATOR, FOR DETAIL SEE -

2 INSTALL O/A AND E/A DUCT EXPOSED ON SERAC STORAGE 112 CEILING. TERMINATE THROUGH EXTERIOR WALL UNDER EXTERIOR OVERHANG AND COVER INLET WITH 3/4" BIRDSCREEN. SLEEVE AND SEAL WALL PENETRATION.

CLEAN 9/9 S/A DIFFUSERS AND REINSTALL IN THEATER 109 CEILING. CONNECT TO NEW DUCTWORK IN ATTIC. (TYP OF 6)

M501

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Corporate No. AECCSA RSA, Job# L5
RSA, Job# L5

FIRST FLOOR HVAC REMODEL PLAN

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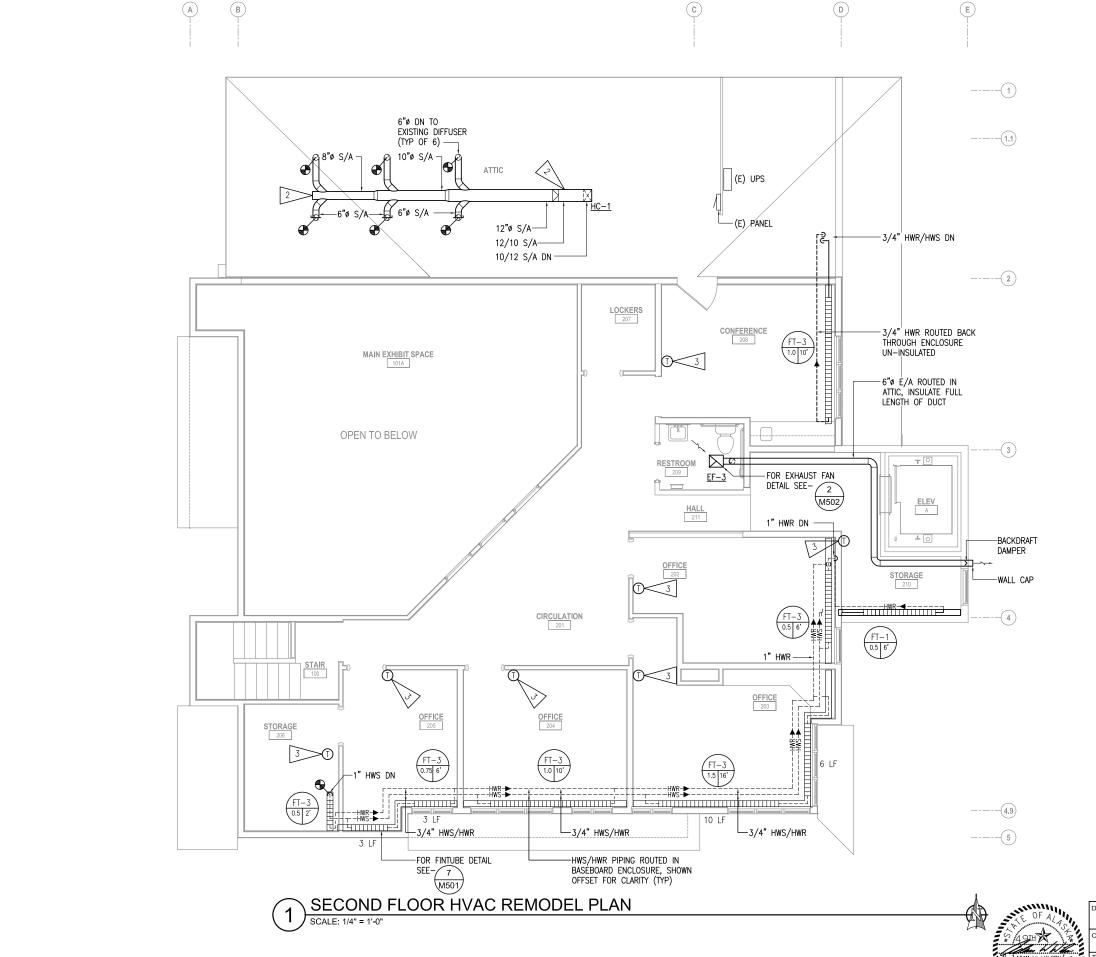
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FIRST FLOOR HVAC REMODEL PLAN

SEWARD VISITOR CENTER REHAB KENAI FJORDS NATIONAL PARK 80,040 PMIS/PKG NO. 184638 SHEET

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DRAWING NO



ALL BASEBOARD ENCLOSURES ON SECOND FLOOR ARE EXISTING TO BE REUSED. PROVIDE NEW FINTUBE INSIDE EXISTING ENCLOSURES. FINTUBE SHALL BE THE SAME AS NEW TYPE FT-1. HEATING WATER SUPPLY AND RETURN PIPING FOR ROOMS 202-206 IS ROUTED THROUGH THE BASEBOARD ENCLOSURE. FOR A TYPICAL DETAIL OF THIS INSTALLATION

M501

2 INSTALL S/A DUCT IN CENTER OF ATTIC TO RETAIN ACCESS TO THEATER ATTIC.

3 INSTALL THERMOSTAT CONTROL WIRING DOWN IN WALL AND UNDER FLOOR TO BASEBOARD. NO PORTIONS OF THE SECOND FLOOR CEILING SHALL BE DEMOLISHED TO INSTALL CONTROL

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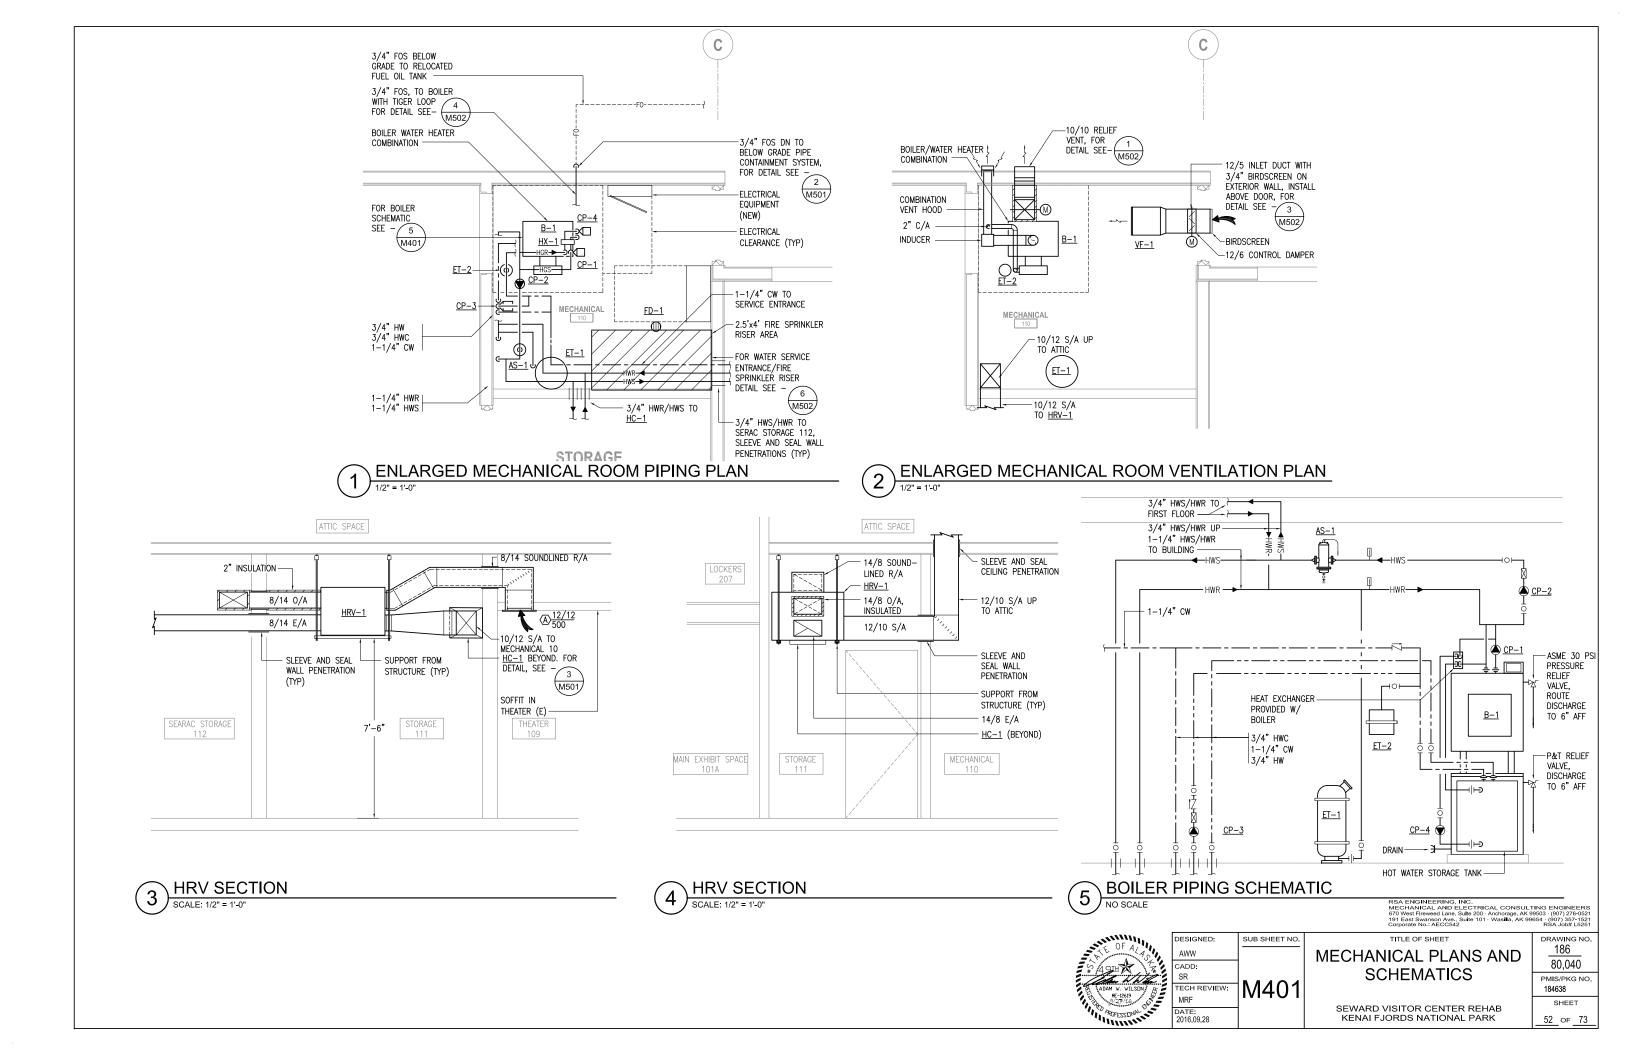
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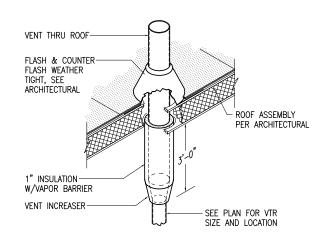
SECOND FLOOR HVAC REMODEL PLAN

SEWARD VISITOR CENTER REHAB KENAI FJORDS NATIONAL PARK


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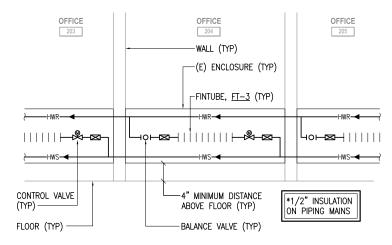





# VENT THROUGH ROOF DETAIL




# UNIT HEATER DETAIL

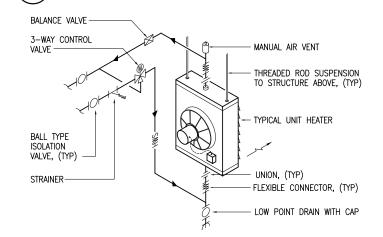


7 FINTUBE PIPING DETAIL-2ND FLOOR

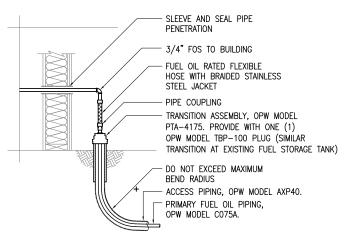


# FUEL OIL PIPE SYSTEM DETAIL

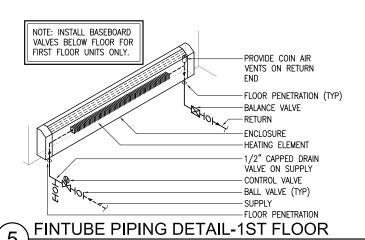


AIRCRAFT CABLE TANK RESTRAINT (TYP), SEE STRUCTURAL

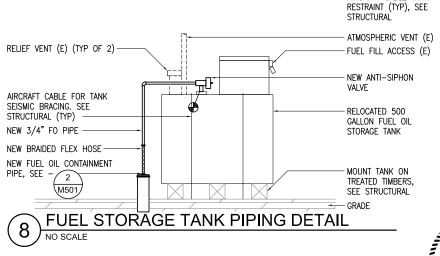

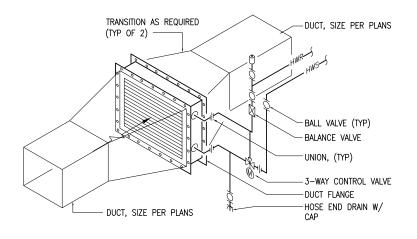

# 3 DUCT MOUNTED HEATING COIL DETAIL NO SCALE

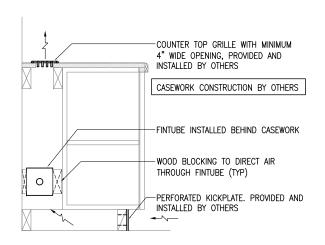

# 6 FINTUBE CASEWORK DETAIL

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Comprate No. - AFCC, Julie 101 - Wasilla, AK 99654 - (907) 357-15
Comprate No. - AFCC, Julie 101 - Wasilla, AK 99654 - (907) 357-15




# MECHANICAL DETAILS

SEWARD VISITOR CENTER REHAB KENAI FJORDS NATIONAL PARK 80,040 PMIS/PKG NO. 184638 SHEET

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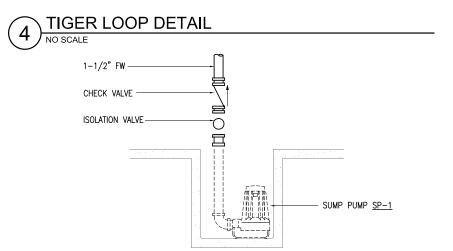


RELIEF AIR DUCT DETAIL

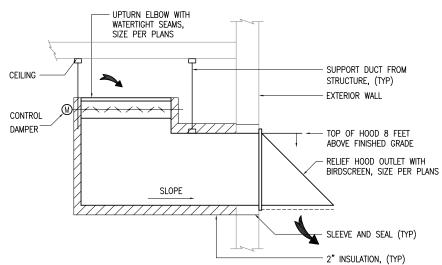
UL LISTED OIL DE-AERATOR AND 10
MICRON SPIN-ON FILTER COMBINATION,
TIGERLOOP MODEL NO. \$220-8

24"x1/4" I.D. STAINLESS STEEL BRAIDED
HOSES TO BURNER


1/2" FUSIBLE VALVE
OIL SAFETY VALVE, WEBSTER OR EQUAL
1/2" CHECK VALVE
1/2" OIL RATED BALL VALVE
1/2" SCHEDULE 40 STEEL




ELEVATOR SUMP PUMP DETAIL

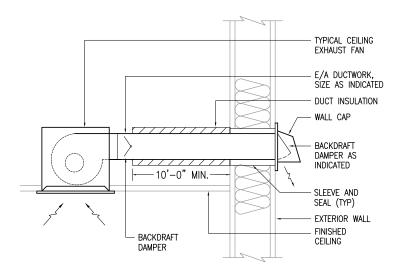

2 CEILING MOUNTED EXHAUST FAN

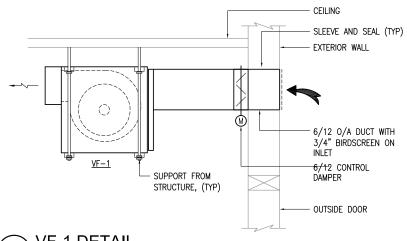

VF-1 DETAIL
NO SCALE

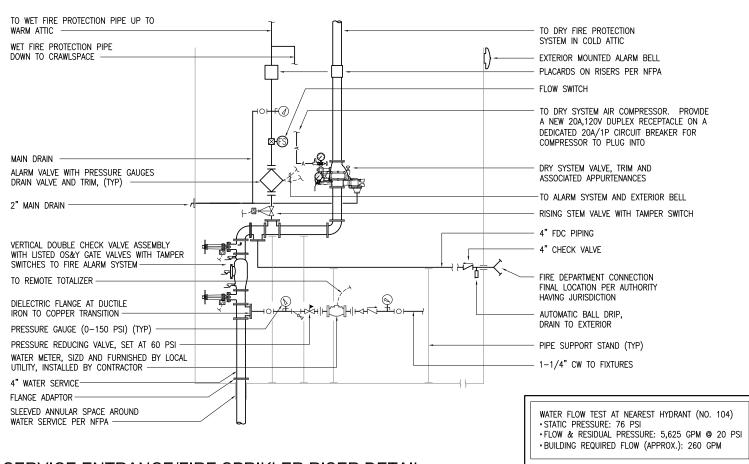

WATER SERVICE ENTRANCE/FIRE SPRIKLER RISER DETAIL

6) WATE


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MECHANICAL DETAILS

SEWARD VISITOR CENTER REHAB KENAI FJORDS NATIONAL PARK PMIS/PKG NO. 184638 SHEET 54 OF 73

DRAWING NO



- THE PIPING LAYOUT SHOWN SHOULD BE UTILIZED AS MUCH AS POSSIBLE TO ROUTE AND SEAL PIPE WITHIN STRUCTURE. COORDINATE THE FINAL PIPE LAYOUT WITH THE NPS CONTRACTING OFFICER PRIOR TO INSTALLATION.
- INSTALL A COMPLETE NFPA 13 WET SPRINKLER SYSTEM THROUGHOUT THE FIRST FLOOR AND CRAWLSPACE. ALL AREAS LIGHT HAZARD OCCUPANCY UNLESS OTHERWISE NOTED.
- 3. ALL HORIZONTAL PIPING TO BE INSTALLED BETWEEN SECOND FLOOR JOISTS, ABOVE FIRST FLOOR CEILING UNLESS OTHERWISE NOTED.
- 4. SEE ARCHITECTURAL CEILING PLANS FOR CEILING CHANGES AND SOFFITS
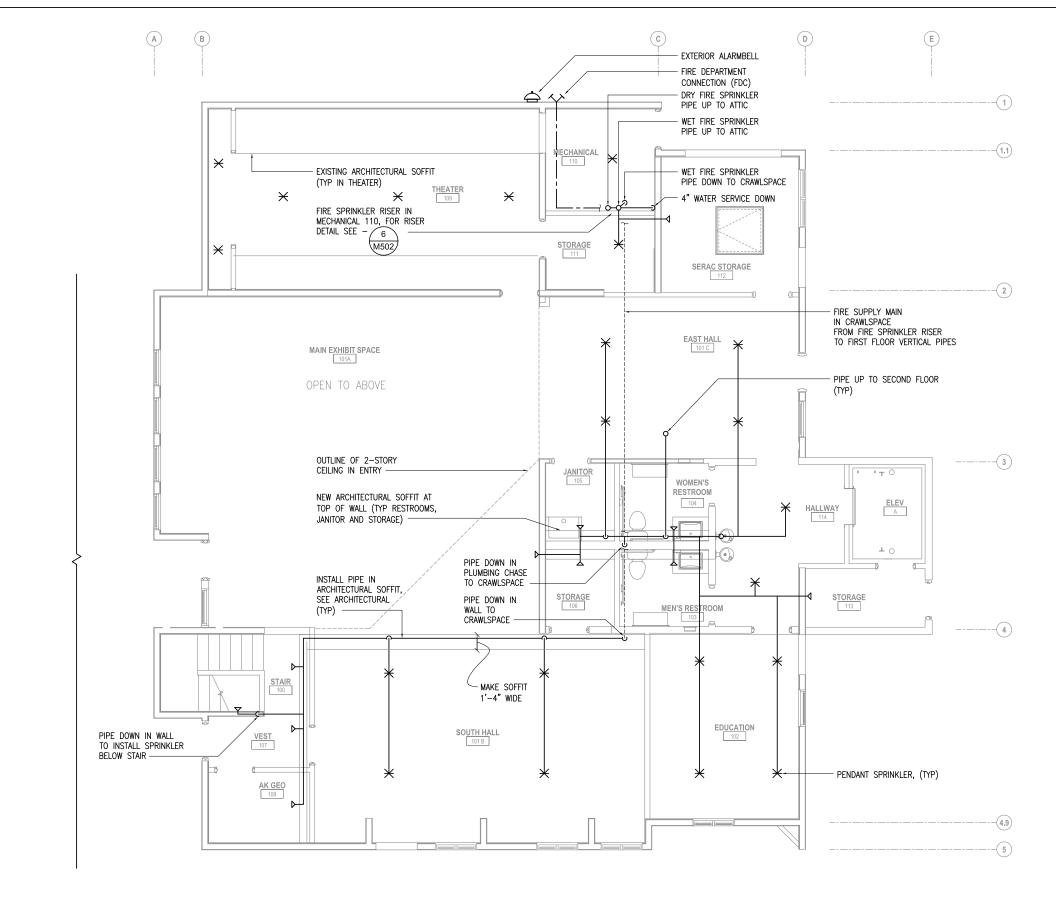
#### LEGEND:

→ PENDANT-TYPE SPRINKLER HEAD

── SIDE WALL-TYPE SPRINKLER HEAD

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Comparate No. - AFCC/524.

FIRST FLOOR FIRE SPRINKLER PROTECTION PLAN




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# FIRST FLOOR FIRE PROTECTION PLAN

SEWARD VISITOR CENTER REHAB KENAI FJORDS NATIONAL PARK 186 80,040 PMIS/PKG NO. 184638 SHEET

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DRAWING NO.



- THE PIPING LAYOUT SHOWN SHOULD BE UTILIZED AS MUCH AS POSSIBLE TO ROUTE AND SEAL PIPE WITHIN STRUCTURE. COORDINATE THE FINAL PIPE LAYOUT WITH THE NPS CONTRACTING OFFICER PRIOR TO INSTALLATION.
- 2. INSTALL A COMPLETE NFPA 13 WET SPRINKLER SYSTEM THROUGHOUT THE SECOND FLOOR.
- 3. INSTALL A COMPLETE NFPA 13 DRY SPRINKLER SYSTEM THROUGHOUT THE ATTIC. ATTIC AREA SIMILAR TO SECOND FLOOR FOOT PRINT.
- 4. ALL SPACES LIGHT HAZARD OCCUPANCY UNLESS OTHER WISE
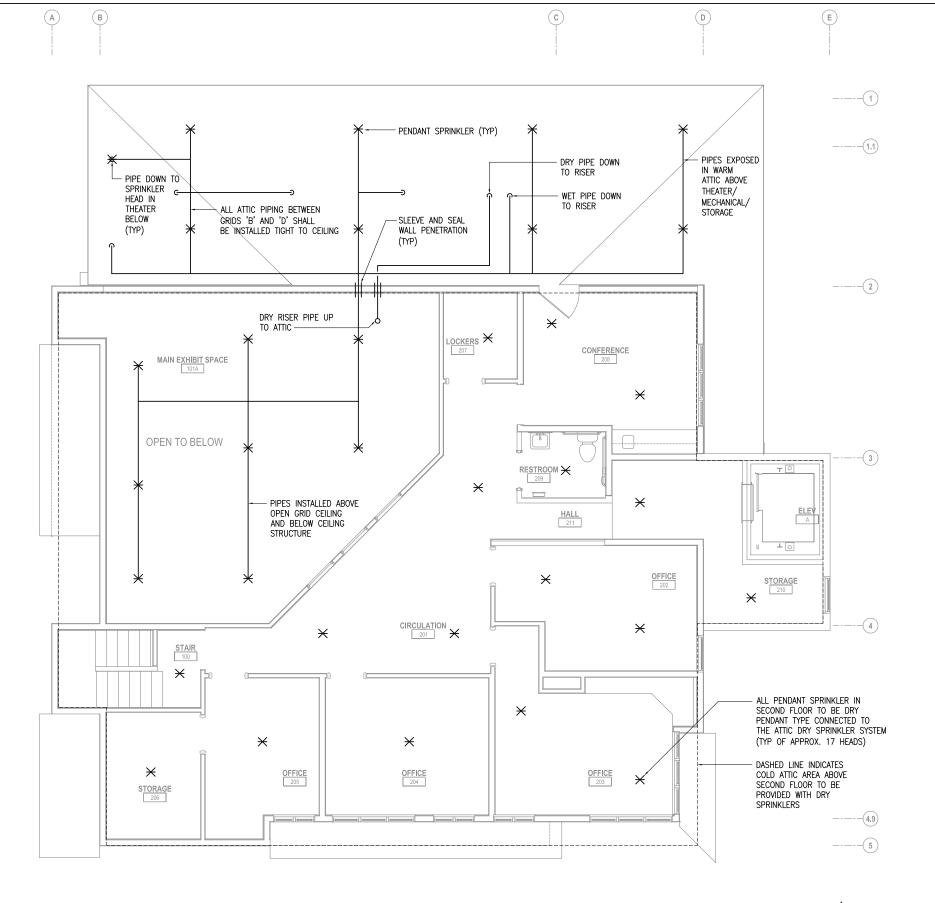
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SECOND FLOOR FIRE SPRINKLER PROTECTION PLAN

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SECOND FLOOR FIRE PROTECTION PLAN

SEWARD VISITOR CENTER REHAB KENAI FJORDS NATIONAL PARK DRAWING NO. 186 80,040 PMIS/PKG NO. 184638

> SHEET 56 OF 73

LEGEND						
0	ROUND LIGHT FIXTURE - PENDANT OR SURFACE MTD CLG	₽DB	DOOR BELL			
Ю	LIGHT FIXTURE - SURFACE MTD ON WALL	•	FIRE ALARM PULL STATION			
0	LIGHT FIXTURE - RECESSED DOWNLIGHT	HD	SPRINKLER ALARM BELL			
H\$	EMERGENCY EXIT LIGHT - SURFACE MTD WALL		FIRE ALARM HORN (WALL, CLG MOUNTED)			
4_}	EMERGENCY LIGHT		FIRE ALARM HORN/STROBE LIGHT (WALL, CLG MOUNTED)			
	LINEAR LIGHT FIXTURE - RECESS MTD	×,×c	FIRE ALARM STROBE LIGHT (WALL, CLG MOUNTED)			
	LINEAR LIGHT FIXTURE - SURFACE MTD CLG	0	HEAT DETECTOR 135° & RATE OF RISE (OR FIXED °F IF NOTED)			
<u> </u>	LINEAR LIGHT FIXTURE - WALL MTD	0	PHOTOELECTRIC SMOKE DETECTOR			
	STRIPLIGHT - PENDANT OR SURFACE MTD CLG	FS	SPRINKLER WATER FLOW SWITCH			
	TRACK LIGHT FIXTURE (# OF HEADS AS SHOWN)	TS	SPRINKLER VALVE TAMPER SWITCH			
A	FIXTURE TAG (LETTER INDICATES TYPE)	ф	DUPLEX RECEPTACLE TO BE REMOVED (DASHED OR DOTTED LINES INDICATE ITEMS TO BE REMOVED TYPICAL)			
\$	SINGLE POLE SWITCH		NOTE TAG (No. INDICATES NOTE)			
\$.	SINGLE POLE SWITCH (LOWERCASE LETTER INDICATES SWITCHING)	X	EXISTING LIGHT FIXTURE TAG (LETTER INDICATES TYPE)			
<b>\$</b> 3	THREE WAY SWITCH, FOUR WAY SWITCH	AFF	ABOVE FINISHED FLOOR			
\$0	DIMMER SWITCH	AFG	ABOVE FINISHED GRADE			
\$ <sub>P</sub>	PILOT LIGHT SWITCH	AHJ	AUTHORITIES HAVING JURISDICTION			
\$os	OCCUPANCY SENSOR WALL SWITCH (DUALTECH)	С	CONDUIT			
\$00s	COMBINATION DIMMER/OCCUPANCY SENSOR WALL SWITCH	CF	CEILING FAN			
<u>©</u>	OCCUPANCY SENSOR - CEILING MOUNTED (DUALTECH)	со	CONDUIT ONLY			
P	PHOTOCELL	CP	CIRCULATION PUMP			
	NM CABLE, CONCEALED	E	DENOTES EXISTING ITEM			
<del> </del>  #10	NUMBER AND SIZE OF WIRES (NO MARKS = 3 #12)	EF	EXHAUST FAN			
A-2	HOMERUN TO PANEL (PANEL AND CIRCUIT No.)	EM	DENOTES EMERGENCY POWER			
_	PANEL	GFCI	GROUND FAULT CIRCUIT INTERRUPTER			
Ф	DUPLEX RECEPTACLE	GRSC	GALVANIZED RIGID STEEL CONDUIT			
42	DUPLEX RECEPTACLE WITH GROUND FAULT CIRCUIT INTERRUPTER	HD	HAND DRYER			
#	QUADRAPLEX RECEPTACLE	HPS	HIGH PRESSURE SODIUM			
•	SPECIAL PURPOSE OUTLET	LED	LIGHT EMITTING DIODE			
⊙=	RECEPTACLE FLOOR OUTLET - DUPLEX	мсв	MAIN CIRCUIT BREAKER			
0	JUNCTION BOX	MLO	MAIN LUGS ONLY			
毗	EMERGENCY PUSHBUTTON SWITCH	NEC	NATIONAL ELECTRICAL CODE			
9	MOTOR (SIZED AS NOTED)	NIC	NOT IN CONTRACT			
<b>\$</b> ⊤	FRACTIONAL HORSEPOWER MOTOR STARTER	NPS	NATIONAL PARK SERVICE			
	DISCONNECT SWITCH	NTS	NOT TO SCALE			
Ճ	COMBINATION DISCONNECT/MAGNETIC MOTOR STARTER	R	DENOTES EXISTING ITEM THAT HAS BEEN RELOCATED			
VFD	VARIABLE FREQUENCY DRIVE WITH INTEGRAL DISCONNECT	ΤΤВ	TELEPHONE TERMINAL BACKBOARD			
SCP	EXISTING SECURITY CONTROL PANEL	TYP	TYPICAL			
©	DOOR POSITION CONTACT	UON	UNLESS OTHERWISE NOTED			
S	EXISTING SECURITY AREA DETECTOR	UH	UNIT HEATER			
WS .	SECURITY MOTION SENSOR	VF	VENTILATION FAN			
FCP	FIRE ALARM CONTROL PANEL	WP	WEATHERPROOF			

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Corporate No.: AECC642



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TITLE OF SHEET

SEWARD VISITOR CENTER REHAB KENAI FJORDS NATIONAL PARK DRAWING NO. 186 80,040

PMIS/PKG NO. 184638

SHEET

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EXISTING LIGHT FIXTURE SCHEDULE				
TYPE	EXISTING LUMINAIRE DESCRIPTION	TOTAL WATTAGE		
A	RECESSED CAN LIGHT.	75		
B	RECESSED CAN LIGHT.	75		
©	3-LAMP, F32T8 1'X4' SURFACE-MOUNTED FLUORESCENT WITH PARABOLIC DIFFUSER.	88		
(D)	2-LAMP 25WT8 WALL MOUNT, 2' WITH ACRYLIC DIFFUSER.	45		
E	2 HEAD EMERGENCY BATTERY PACK UNIT.	4		
F	4-LAMP, F32T8 2'X4' SURFACE-MOUNTED FLUORESCENT WITH PARABOLIC DIFFUSER.	118		
(3)	2-LAMP, F32T8 1'X4' SURFACE-MOUNTED WRAP-AROUND FLUORESCENT.	60		
$\oplus$	6-LAMP, F32T8 4'X4' SURFACE-MOUNTED FLUORESCENT WITH DIFFUSER.	176		
(1)	EXTERIOR LED WALL MOUNT FIXTURE.	25		
J	EXTERIOR BARN LIGHT HPS SURFACE MOUNT FIXTURE.	70		
K	2-LAMP 25WT8 WALL MOUNT.	45		
(L)	2-LAMP, F32T8 2'X4' SURFACE-MOUNTED FLUORESCENT WITH CLEAR DIFFUSER.	60		
M	75W INCANDESCENT TRACK MOUNTED SPOTLIGHT.	75		
N	EXTERIOR WALL MOUNT LUMINARIE.	70		
0	KEYLESS SOCKET.	75		
P	SAME AS TYPE 'O' EXCEPT WITH PULL CHAIN.	75		
0	2-LAMP, F32T8 1'X4' RECESSED-MOUNTED FLUORESCENT.	60		
R	EMERGENCY BUG EYE.	12		
<u> </u>	EXTERIOR SURFACE-MOUNTED QUARTZ FLOOD LIGHT.	500		
(T)	2-LAMP, F32T8 1'X4' SURFACE-MOUNTED DIRECT/INDIRECT FLUORESCENT.	60		
	INCANDESCENT COMBINATION LIGHT/FAN.	75		
	INCANDESCENT LANTERN WALL SCONCE	60		
W	2-LAMP, 25WT8 UNDER CABINET FLUORESCENT.	45		
$\overline{\otimes}$	LED EXIT SIGN.	3		

#### **GENERAL SCHEDULE NOTES:**

A. SEE PLANS FOR FIXTURES DESIGNATED AS EMERGENCY, PROVIDE EMERGENCY BALLAST IN FIXTURES INDICATED. SEE SPECIFICATION SECTION 26 50 00 FOR REQUIREMENTS.

			LIGHT FIXTURE SCHEDULE					
TYPE	LOCATION	MANUFACTURER AND CATALOG NUMBER (OR APPROVED EQUAL)	LUMINAIRE DESCRIPTION	MOUN TYPE	TING HEIGHT	LAMPS	BALLAST/DRIVER	TOTAL
Α	THEATER	SONNEMAN #2313.16	15.75"DIAx12"H LED RING PENDANT WITH 6' ADJUSTABLE CABLE, 2"H FROSTED ACRYLIC SHADE AND BRIGHT SATIN FINISH.	PENDANT	9'-0" TO BOTTOM		120V LED DRIVER, DIMMABLE BY ELV OR INCANDESCENT DRIVER	19
В	AK GEO, OFFICES	LITHONIA LIGHTING #STL4-30L-MVOLT-EZ1- LP835	10"Wx4"Lx4"H LED SURFACE VOLUMETRIC FIXTURE WITH CURVED LINEAR ACRYLIC LENS AND WHITE FINISH.	SURFACE	CEILING	3500K LED 3049LM	120/277V 0-10V, DIMMING DRIVER	28
B2	CONFERENCE, CIRCULATION, LOCKERS, OFFICES	LITHONIA LIGHTING #STL4-40L-MVOLT-EZ1- LP835	SAME AS TYPE 'B' FIXTURE EXCEPT WITH A HIGHER LUMEN OUTPUT.	SURFACE	CEILING	3500K LED 3834LM	120/277V 0-10V, DIMMING DRIVER	35
В3	EDUCATION, SERAC, STORAGE	LITHONIA LIGHTING #STL4-48L-MVOLT-EZ1- LP835	SAME AS TYPE 'B2' FIXTURE EXCEPT WITH A HIGHER LUMEN OUTPUT.	SURFACE	CEILING	3500K LED 4850LM	120/277V 0-10V, DIMMING DRIVER	45
С	RESTROOMS	LITHONIA LIGHTING #WL2-22L-EZ1-LP835	4-3/4"Wx24"Lx3-11/16"H LED WALL FIXTURE WITH LINEAR FACETED LENS, WHITE FINISH.	WALL	ABOVE MIRROR	3500K LED 2200LM	120/277V 0-10V, DIMMING DRIVER	21
C2	STORAGE, ELEVATOR	LITHONIA LIGHTING #WL4-40L-EZ1-LP835	4-3/4"Wx51"Lx3-11/16"H LED WALL FIXTURE WITH LINEAR FACETED LENS, WHITE FINISH.	WALL OR SURFACE	SEE PLANS	3500K LED 4000LM	120/277V 0-10V, DIMMING DRIVER	40
<b>C</b> 3	STAIR 1, VEST 107	LITHONIA LIGHTING #WL4-40L-EZ1-LP835-NES7	SAME AS LIGHT FIXTURE C2, EXCEPT WITH PIR INTEGRAL OCCUPANCY SENSOR.	SURFACE	CEILING	3500K LED 4000LM	120/277V 0-10V, DIMMING DRIVER	40
D	MECHANICAL, STORAGE AND JANITOR ROOMS	PHILIPS #LF-4-FR-39-35-U-DZT	2'Wx4'Lx2"H LED SURFACE STRIP, 100% FROST LENS AND WHITE FINISH.	SURFACE	CEILING	3500K LED, 4000LM	120/277V 0-10V, DIMMING DRIVER	33
Ε	CIRCULATION, OFFICES, RESTROOMS AND HALLWAY	GOTHAM LIGHTING #EVO-35/10-4AR-WD-LD- MVOLT-EZ1-TRW	NOMINAL 4" DIAMETER LED OPEN DOWNLIGHT, WIDE LIGHT DISTRIBUTION, CLEAR APERTURE TRIM AND MATTE DIFFUSE FINISH.	RECESSED	CEILING	3500K LED 1189LM	120V 0-10V, DIMMING DRIVER	13
F	EXTERIOR WALL	HUBBELL #VBGL-1	5.25"DIAx10.37"L LED EXTERIOR WALL SCONCE WITH RUGGED DIE CAST ALUMINUM HOUSING AND CAST ALUMINUM GUARD, FROSTED LENS, ALUMINUM FINISH, UL WET LISTING AND VAPORTITE.	WALL	7'-6"	4100K LED 757LM	120/277V 250mA -22F RATED DRIVER	11
Н	THEATER, HALL 211, CIRCULATION 201	EATON #PD6R-10-ED010-PDM6A-835 -692-SC-BFR56FL	HALO COMMERCIAL NOMINAL 6" DIAMETER APERATURE LED DOWNLIGHT RETROFIT, BEAM FORMING REFLECTOR KIT, FLOOD DISTRIBUTION, SPECULAR CLEAR WITH WHITE FLANGE FINISH.	RECESSED	CEILING	3500K LED 1000LM	120/277V 0-10V AND LE/TE PHASE CUT, DIMMING DRIVER	12
X	EXITS	LITHONIA LIGHTING #LQM-S-W-3-R-120/277 -ELN	2"Dx11.75"Lx8"H LED THERMOPLASTIC EXIT SIGN, RED LETTERS, WHITE HOUSING, SINGLE FACE WITH EXTRA FACEPLATE AND NICKEL CADMIUM BATTERY.	SURFACE	SEE PLANS	N/A	120/277V	1
X1	EMERGENCY EGRESS	LITHONIA LIGHTING #ELMLT-B-LP06VS-LTP-SD	3.75"Dx12.5"Lx5"H LOW PROFILE LED THERMOPLASTIC EMERGENCY LIGHT, SEALED MAINTENANCE FREE LITHIUM IRON PHOSPHATE BATTERY, SELF DIAGNOSTIC, DAMP LISTED AND BLACK HOUSING.	WALL	7'-6"	,	120/277V INPUT, 9.66VDC LITHIUM IRON PHOSPHATE BATTERY	19

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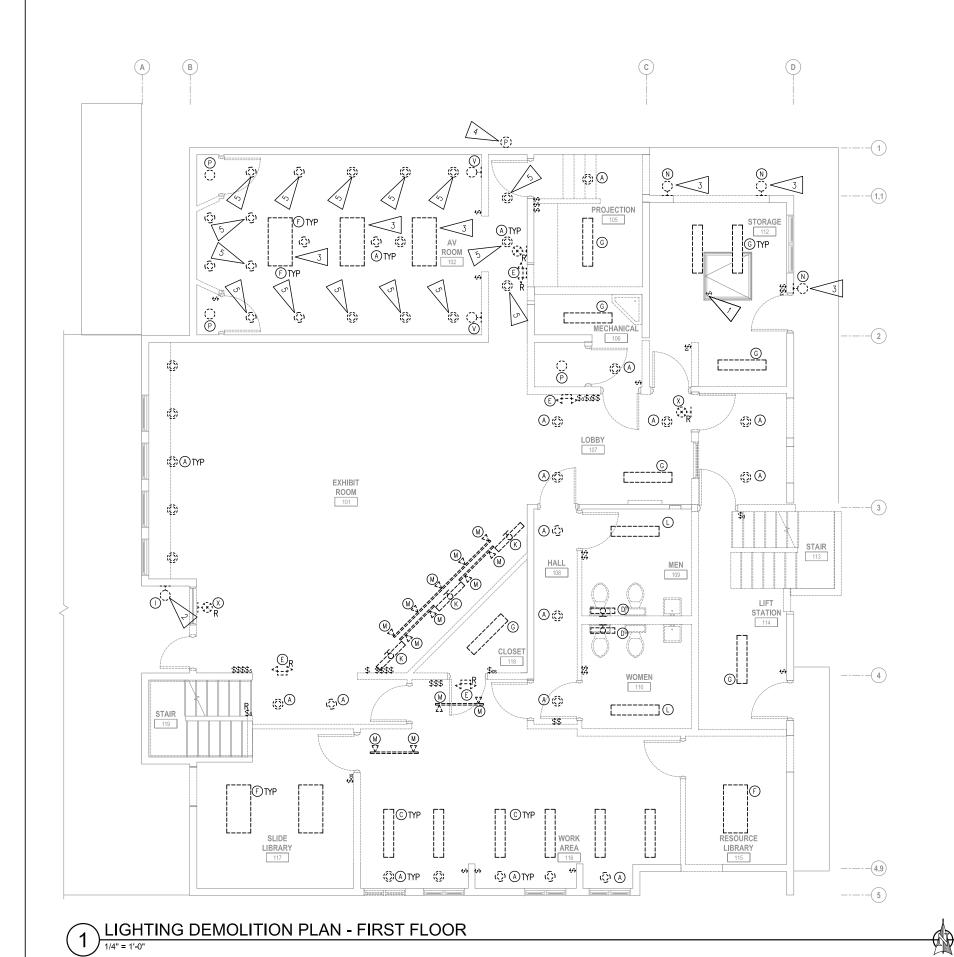


DESIGNED:	SUB SHEET NO.	
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CADD: MJC		
TECH REVIEW:	F002	
CPL		
DATE		

TITLE OF SHEET
SCHEDULES

186 80,040 PMIS/PKG NO. 184638

SEWARD VISITOR CENTER REHAB KENAI FJORDS NATIONAL PARK SHEET 58 OF 73





- A. THE INFORMATION SHOWN ON THIS DRAWING IS TAKEN FROM AS—BUILT DRAWINGS AND A NON—DESTRUCTIVE WALK THROUGH OF THE FACILITY. THERE IS NO WARRANTY OR GUARANTEE AS TO THE ACCURACY OF THE INFORMATION SHOWN HERE—IN. THE CONTRACTOR SHALL FIELD VERIFY ALL ITEMS SCHEDULED FOR DEMOLITION PRIOR TO START OF WORK.
- B. THE GOVERNMENT SHALL HAVE FIRST RIGHT OF REFUSAL ON ALL SALVAGEABLE MATERIALS. THE CONTRACTOR SHALL DELIVER SALVAGED MATERIALS TO A WAREHOUSE AS DIRECTED BY THE CONTRACTING OFFICER. THE CONTRACTOR SHALL DISPOSE OF, OFF SITE, ALL UNWANTED MATERIALS.
- C. DASHED OR DOTTED LINES INDICATE ITEMS TO BE REMOVED. SOLID LINES INDICATE EXISTING ITEMS TO REMAIN.
- D. DISCONNECT AND SALVAGE ALL ITEMS NOTED FOR RELOCATION. DEMOLISH CONDUIT, CONDUCTORS, BOXES, ETC. TO ACCOMMODATE CONSTRUCTION. SEE REMODEL PLANS FOR NEW LOCATION

- EXISTING SWITCH AND (8) EXISTING TYPE '0' LIGHT FIXTURES LOCATED IN CRAWL SPACE TO REMAIN. SWITCH LOCATED INSIDE CRAWL SPACE OPENING. SEE 1/E201 FOR HOMERUN DESIGNATION.
- 2. DISCONNECT AND RETURN TO OWNER LED WALL PACK. SALVAGE ELECTRICAL CIRCUIT FOR RE—CONNECTION.
- DISCONNECT AND DEMOLISH LIGHT FIXTURE. SALVAGE ELECTRICAL CIRCUIT FOR RE—CONNECTION.
- 4. DISCONNECT AND DEMOLISH PHOTOCELL. SALVAGE ELECTRICAL CIRCUIT FOR RE-CONNECTION.
- 5. EXISTING FIXTURE HOUSING AND ELECTRICAL CIRCUIT TO REMAIN. SEE REMODEL PLANS FOR NEW LED TRIM KIT.

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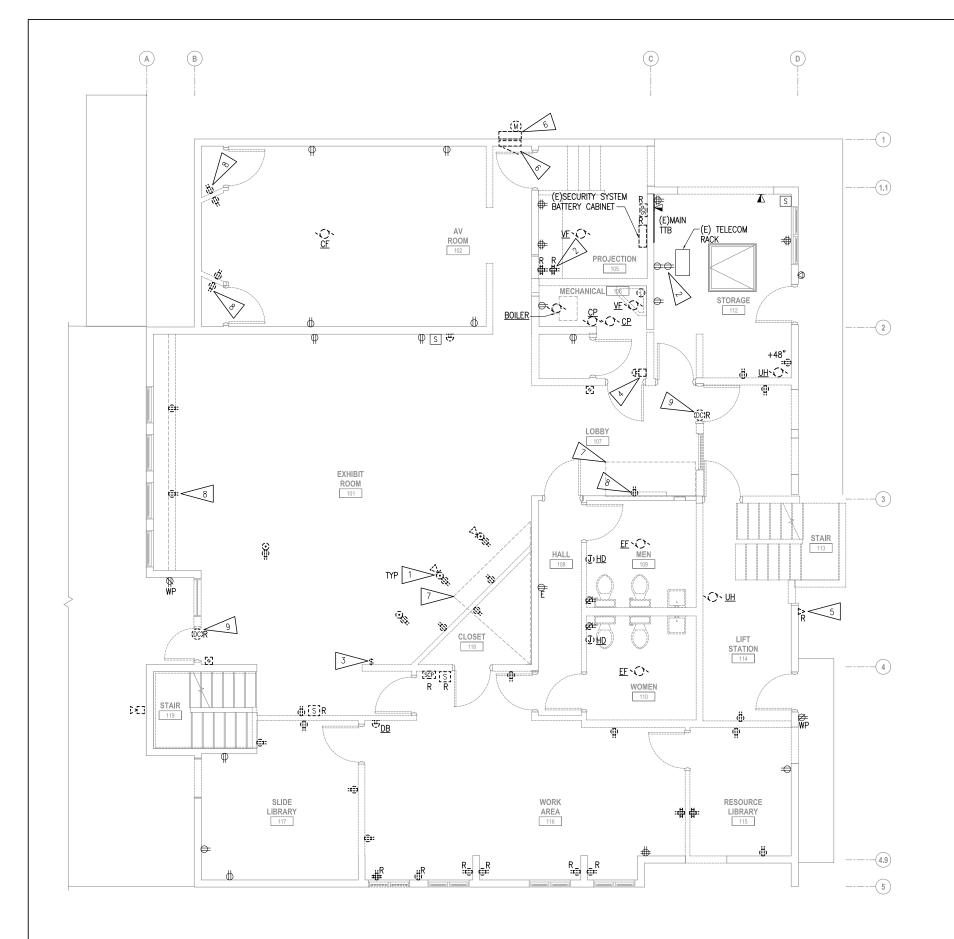
LIGHTING DEMOLITION PLAN - FIRST FLOOR

> SEWARD VISITOR CENTER REHAB KENAI FJORDS NATIONAL PARK

80,040 PMIS/PKG NO. 184638 SHEET

59 of <u>73</u>

DRAWING NO



A. SEE GENERAL NOTES ON E101.

#### SHEET NOTES:

- 1. RECEPTACLES LOCATED AT RECEPTIONIST DESK.
- RECEPTACLE SHOWN IN FRONT FOR CLARITY. RECEPTACLE LOCATED ABOVE OTHER RECEPTACLE.
- 3. DISCONNECT AND DEMOLISH CEILING FAN CONTROLLER SWITCH.
- 4. DISCONNECT AND DEMOLISH BOILER EMERGENCY SHUTDOWN SWITCH.
- 5. EXISTING ANTENNA TO BE RELOCATED. NPS TO REMOVE AND REINSTALL ALL COMMUNICATION CABLES AND EQUIPMENT.
- 6. SEE 1/E601 ELECTRICAL ONE-LINE DIAGRAM.
- DEMOLISH EXISTING CABLE AND EQUIPMENT IN CRAWLSPACE BELOW TO ALLOW FOR NEW FLOOR CUT OUT AND EXHIBIT DISPLAYS. EXTEND AND RECONNECT ANY EXISTING WIRING SERVING EQUIPMENT TO REMAIN.
- 8. DISCONNECT AND DEMOLISH RECEPTACLE. SALVAGE CONDUCTORS FOR NEW RECEPTACLE.
- DISCONNECT DOOR CONTACT AND SALVAGE ELECTRICAL CIRCUIT FOR RE-CONNECTION. SEE 1/E401 FOR RELOCATION OF DOOR CONTACT.

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POWER & SIGNAL
DEMOLITION PLAN FIRST FLOOR

FIRST FLOOR
SEWARD VISITOR CENTER REHAB
KENAI FJORDS NATIONAL PARK


PMIS/PKG NO. 184638
SHEET
60 OF 73

DRAWING NO.

80,040

1 POWER & SIGNAL DEMOLITION PLAN - FIRST FLOOR

**/** 1/4" = 1'-0"

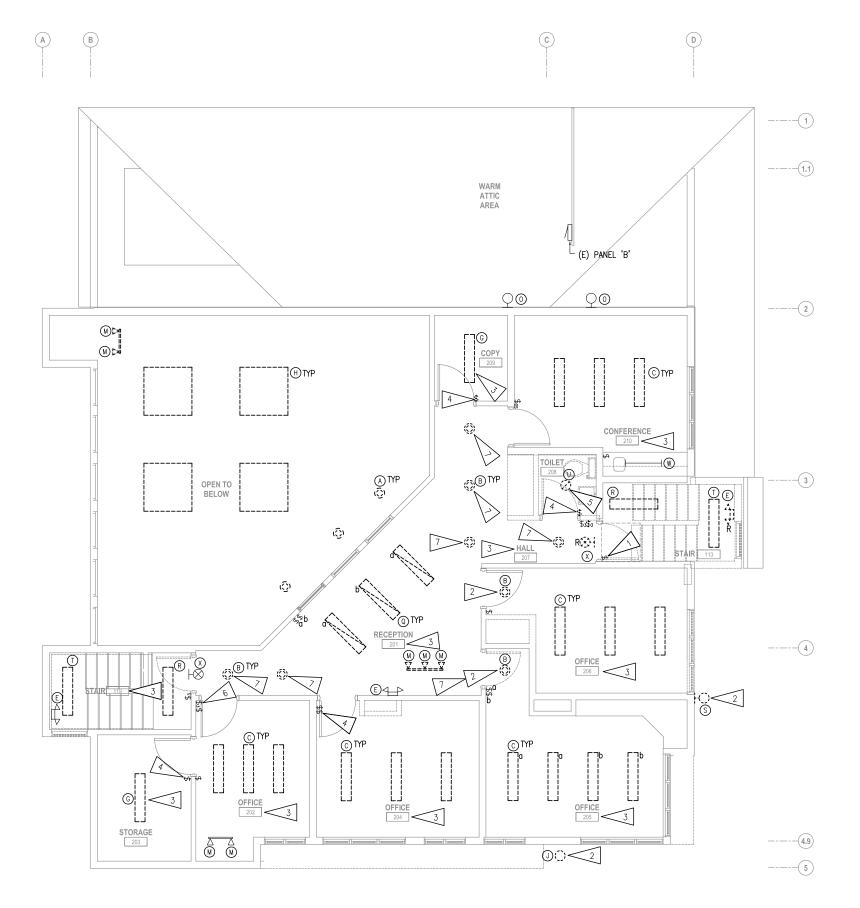

A. SEE GENERAL NOTES ON E101.

#### SHEET NOTES:

- 1. EXISTING SWITCH AND (4) EXISTING TYPE 'O' LIGHT FIXTURES LOCATED IN ATTIC TO REMAIN. SWITCH LOCATED INSIDE ATTIC SPACE OPENING.
- 2. DEMOLISH LIGHT FIXTURE AND ELECTRICAL CIRCUIT BACK TO SOURCE.
- 3. UON, ALL DEMOLISHED LIGHTS IN ROOM WILL BE A ONE-FOR-ONE REPLACEMENT. SALVAGE ELECTRICAL CIRCUIT FOR RE-CONNECTION.
- 4. DEMOLISH LIGHT SWITCH AND SALVAGE ELECTRICAL CIRCUIT FOR RE—CONNECTION.
- 5. DEMOLISH LIGHT FIXTURE AND SALVAGE ELECTRICAL CIRCUIT FOR
- 6. EXISTING THREE WAY SWITCH LOCATED IN OFFICE IS FOR SWITCHING HALLWAY LIGHTING.
- 7. EXISTING FIXTURE HOUSING TO REMAIN. SEE REMODEL PLANS FOR NEW LED TRIM KIT.



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TITLE OF SHEET LIGHTING DEMOLITION PLAN - SECOND FLOOR


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DRAWING NO.

SEWARD VISITOR CENTER REHAB KENAI FJORDS NATIONAL PARK

61 of 73

LIGHTING DEMOLITION PLAN - SECOND FLOOR

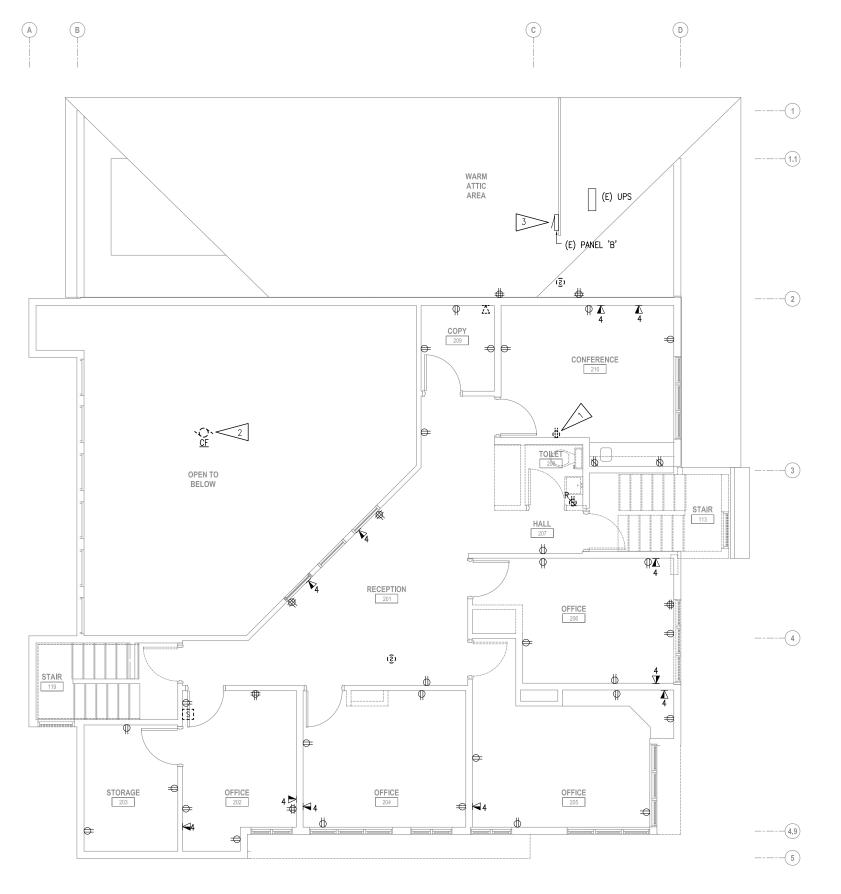

A. SEE GENERAL NOTES ON E101.

#### SHEET NOTES:

- 1. DISCONNECT AND DEMOLISH RECEPTACLE. SALVAGE CONDUCTORS FOR NEW GFCI RECEPTACLE.
- 2. DISCONNECT AND DEMOLISH CEILING FAN.
- 3. SEE 1/E601 ELECTRICAL ONE-LINE DIAGRAM.



TITLE OF SHEET SUB SHEET NO. **POWER & SIGNAL DEMOLITION PLAN -**E104 **SECOND FLOOR** 

PMIS/PKG NO. SEWARD VISITOR CENTER REHAB KENAI FJORDS NATIONAL PARK

184638 SHEET 62 of 73

DRAWING NO.

80,040

POWER & SIGNAL DEMOLITION PLAN - SECOND FLOOR

- A. UON, PORTIONS OF EXISTING ELECTRICAL CIRCUITRY MAY BE RE-USED IF CODE COMPLIANT. EXTEND RECONNECT OR REPLACE AS REQUIRED. SEE SHEET FOR HOMERUN DESIGNATION TO PANEL
- WHERE ITEMS ARE NOTED AS BEING RELOCATED, REINSTALL SALVAGED EQUIPMENT IN NEW LOCATION SHOWN. EXTEND AND RECONNECT TO EXISTING CIRCUIT AS REQUIRED, UON.
- .C. EXTERIOR LIGHTS SHALL BE CONTROLLED BY NEW PHOTOCELL.
- . EXHIBIT LIGHTING FIXTURES NIC. ROUGH—IN PER DIVISION 26 UNLESS OTHERWISE NOTED.
- REFER TO EXHIBIT LIGHTING SHEETS L-1, L-2 AND DIVISION 11 FOR FIXTURE TYPES AND LOCATIONS.
- F. WIRING NOT SHOWN FOR CLARITY, BUT SHALL BE PROVIDED BY CONTRACTOR TO MEET NEC REQUIREMENTS PER THE CIRCUIT ASSIGNMENTS INDICATED.
- G. CONNECT EMERGENCY LIGHT FIXTURES AND EXIT SIGNS TO THE UN-SWITCHED LEG OF LOCAL LIGHTING CIRCUIT.
- H. UON, PROVIDE 2#12, 1#12 GND FOR ALL 15 AND 20A/1P CIRCUITS. SEE SHEET FOR HOMERUN DESIGNATIONS.
- PROVIDE A DEDICATED NEUTRAL CONDUCTOR FOR ALL CIRCUITS CONNECTED TO THE DIMMING PANEL 'DIM'.

#### SHEET NOTES:


- FIELD-COORDINATE LOCATION OF LIGHTS WITH MECHANICAL PIPING AND EQUIPMENT PRIOR TO INSTALLATION.
- 2. EM FIXTURE TO BE CONNECTED TO INVERTER. SEE 1/E202 FOR LOCATION OF INVERTER AND 2/E701 FOR DETAIL.

PROVIDE NEW PHOTOCELL. SEE 2/E701.

- . TO ELEVATOR PIT RECEPTACLE. SEE 1/E501.
- 5. OCCUPANCY SENSOR IS INTEGRAL TO FIXTURE.
- 6. DIMMING CONTROL STATION FOR PANEL 'DIM'. SEE 2/E601.
- . IN CRAWLSPACE, REPLACE ALL EXISTING INCANDESCENT LIGHT BULBS IN KEYLESS SOCKETS WITH NEW LED SCREW IN BULBS (CREE 13.5W, 1100 LUMENS, 2700K, 75W INCANDESCENT REPLACEMENT BULB OR APPROVED EQUAL). ASSUME 8 KEYLESS SOCKETS IN CRAWLSPACE FOR BIDDING PURPOSES. SEE SHEET FOR HOMFRUN DESIGNATION.
- 8. CONNECT LIGHT SWITCH TO CONTROL LOCAL EXHAUST FAN. SEE 1/E301.
  - MOUNT AND CENTERED WITHIN BLACK BAND ON THE WALL. SEE INTERIOR ELEVATIONS.
- 3-BUTTON PUSH STATION FOR CONTROL OF EXHIBIT LIGHTS (MAIN EXHIBIT, EAST GALLERY, SOUTH HALL). CONNECT TO PANEL 'DIM'. COORDINATE LOCATION WITH INFODESK PRIOR TO ROUGH-IN.
- 4-BUTTON PUSHBUTTON CONTROLLER FOR THEATER LIGHTS.
   CONNECT TO DIMMER PANEL. SEE 2/E601. COORDINATE WITH CONTRACTING OFFICER FOR SCENES AND LABELING.
- 12. FIELD VERIFY LOCATION WITH CONTRACTING OFFICER BEFORE ROUGH—IN.
- MOUNT 36" ABOVE PIT FLOOR. COORDINATE WITH ELEVATOR SHOP DRAWINGS PRIOR TO ROUGH-IN.

#### **EXHIBIT LIGHTING CONNECTION SCHEDULE NOTES:**

- PROVIDE AND INSTALL CEILING MOUNTED J-BOX FOR CONNECTION TO LIGHT FIXTURE. EXHIBIT LIGHTING FIXTURES NIC.
- B. PROVIDE JUNCTION BOX LOCATED IN CRAWLSPACE FOR CONNECTION TO UNDER FLOOR WAVELIGHT FIXTURES. EXHIBIT LIGHTING FIXTURES NIC.
- C. PROVIDE JUNCTION BOX LOCATED IN CRAWLSPACE FOR CONNECTION TO LIGHT FIXTURE. EXHIBIT FIXTURES FIXTURES NIC.

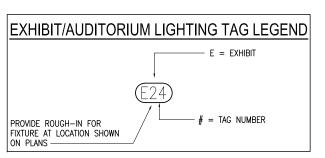

Е	XHIBIT LIGHTING	CONNE	CTION	SCHE	DULE
TAG	DESCRIPTION	WATTAGE	CIRCUIT	DIMMER	NOTES
E01)	1-CIRCUIT TRACK LIGHTING	320	DIM-1	YES	Α
E02)	1-CIRCUIT TRACK LIGHTING	320	DIM-2	YES	Α
E03	1-CIRCUIT TRACK LIGHTING	320	DIM-3	YES	Α
E04)	1-CIRCUIT TRACK LIGHTING	700	DIM-4	YES	Α
E05	1-CIRCUIT TRACK LIGHTING	700	DIM-5	YES	Α
E06	1-CIRCUIT TRACK LIGHTING	700	DIM-6	YES	Α
<b>E</b> 07	1-CIRCUIT TRACK LIGHTING	700	DIM-7	YES	Α
E08	1-CIRCUIT TRACK LIGHTING	700	DIM-8	YES	Α
E09	1-CIRCUIT TRACK LIGHTING	150	DIM-9	YES	С
Œ10	1-CIRCUIT TRACK LIGHTING	1400	DIM-10	YES	Α
Œ11)	1-CIRCUIT TRACK LIGHTING	1400	DIM-11	YES	Α
E12)	1-CIRCUIT TRACK LIGHTING	1400	DIM-12	YES	Α
Ē13	1-CIRCUIT TRACK LIGHTING	1400	DIM-13	YES	Α
E14)	1-CIRCUIT TRACK LIGHTING	1400	DIM-14	YES	Α
Œ15)	1-CIRCUIT TRACK LIGHTING	1400	DIM-15	YES	Α
Œ16	1-CIRCUIT TRACK LIGHTING	1400	DIM-16	YES	Α
<b>E</b> 17	DECORATIVE PENDANT MOUNT	19	DIM-17	YES	Α
E18)	DECORATIVE PENDANT MOUNT	19	DIM-17	YES	Α
E19	DECORATIVE PENDANT MOUNT	19	DIM-17	YES	Α
E20	DECORATIVE SURFACE MOUNT	201	DIM-18	YES	Α
E21)	DECORATIVE SURFACE MOUNT	201	DIM-18	YES	Α
E22	DECORATIVE SURFACE MOUNT	201	DIM-18	YES	Α
E24)	WAVELIGHT PROJECTOR	15	DIM-19	YES	В
Ē25	WAVELIGHT PROJECTOR	15	DIM-19	YES	В
Ē26	WAVELIGHT PROJECTOR	15	DIM-20	YES	В
E27)	WAVELIGHT PROJECTOR	15	DIM-20	YES	В
Ē28	MICRO-SPOTLIGHTS	75	DIM-21	YES	С

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(c)

-DIMMER PANEL

A-18

EAST HALL 101 C

WOMEN'S

ESTROOM

SEE 2/E601. A-20

STORAGE

**O**(E28)

PANEL 'A'

A-18

A-18

\$<sub>C2</sub> +84" A-18

STORAGE

X1) DIM-24 9

STORAGE 106

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LIGHTING REMODEL
PLAN - FIRST FLOOR
& EXHIBIT SCHEDULE

SEWARD VISITOR CENTER REHAB

KENAI FJORDS NATIONAL PARK

PMIS/PKG NO 184638 SHEET 63\_OF\_73

DRAWING NO

80,040

LIGHTING REMODEL PLAN - FIRST FLOOR

A

(B)

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DIM-23

OUTLINE OF 2ND

STORY CEILING ENTRY

DIM-23

MAIN EXHIBIT SPACE

DIM-22, TYP

-DIM-22, TYP

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DIM-25


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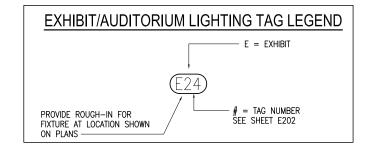
9 DIM-24

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@E10

1/4" = 1'-0"



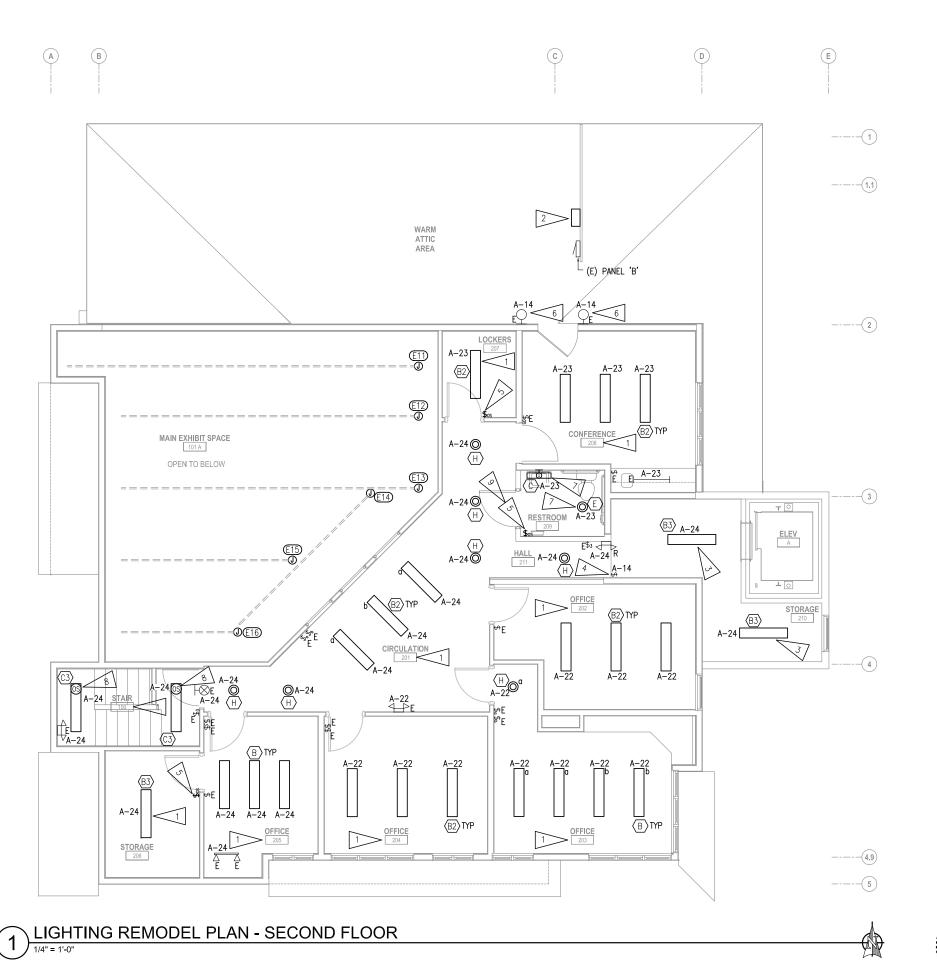

- A. SEE GENERAL NOTES ON E201.
- B. SEE EXHIBIT LIGHTING CONNECTION SCHEDULE AND SCHEDULE NOTES ON F201

#### SHEET NOTES:

- UON, NEW LIGHTS IN ROOM ARE ONE-FOR-ONE REPLACEMENT.
   RE-CONNECT SALVAGED ELECTRICAL CIRCUIT TO NEW LIGHTS. IF
   NECESSARY EXTEND AND RECONNECT TO EXISTING ELECTRICAL CIRCUIT.
- FIELD LOCATE EMERGENCY LIGHTING INVERTER IN ATTIC AREA ON PONY WALL. SEE 2/E701.
- 3. PROVIDE NEW LIGHT FIXTURES AND CONNECT WITH NEW CONDUCTORS TO EXISTING HALLWAY LIGHT CIRCUIT AND SWITCHING.
- 4. IN ATTIC, REPLACE ALL EXISTING INCANDESCENT LIGHT BULBS IN KEYLESS SOCKETS WITH NEW LED SCREW IN BULBS (CREE 13.5W, 1100 LUMENS, 2700K, 75W INCANDESCENT REPLACEMENT BULB OR APPROVED EQUAL). ASSUME 8 KEYLESS SOCKETS IN ATTIC FOR BIDDING PURPOSES.
- 5. PROVIDE NEW LINE VOLTAGE OCCUPANCY SENSOR SWITCH AND RECONNECT TO SALVAGED CIRCUIT. EXTEND AND CONNECT CIRCUITRY AS REQUIRED.
- 6. REPLACE INCANDESCENT LIGHT BULB WITH SCREW IN TYPE LED BULB. SEE SHEET NOTE #4 ABOVE FOR CREE LED BULB TO USE.
- 7. PROVIDE NEW LIGHT FIXTURES AND CONNECT TO SALVAGED CIRCUIT. EXTEND AND CONNECT CIRCUITRY AS REQUIRED.
- 8. OCCUPANCY SENSOR IS INTEGRAL TO FIXTURE.
- 9. CONNECT TO CONTROL LOCAL EXHAUST FAN. SEE 1/E302.

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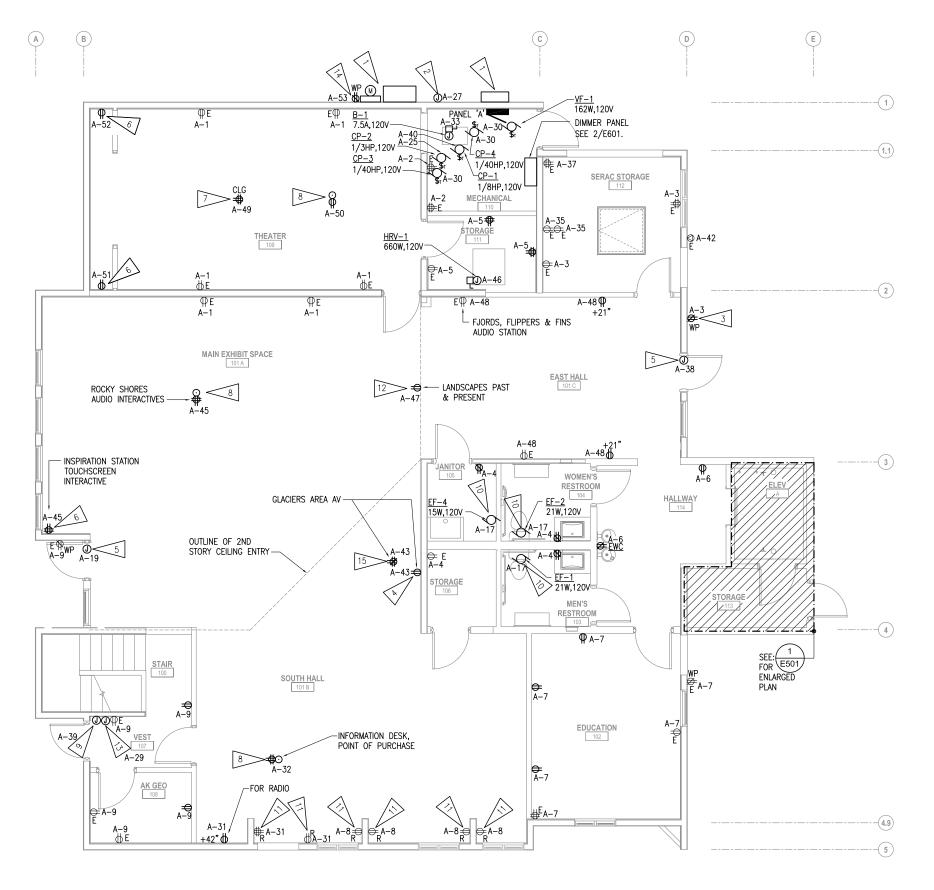


JB SHEET NO.	TITLE OF SHEET
	LIGHTING REMODEL
202	PLAN - SECOND FLOOR

SEWARD VISITOR CENTER REHAB KENAI FJORDS NATIONAL PARK 186 80,040 PMIS/PKG NO. 184638 SHEET

64 of 73

DRAWING NO



POWER REMODEL PLAN - FIRST FLOOR

#### **GENERAL NOTES**

- A. UON, PORTIONS OF EXISTING ELECTRICAL CIRCUITRY MAY BE RE—USED IF CODE COMPLIANT. EXTEND RECONNECT OR REPLACE AS REQUIRED. SEE SHEET FOR HOMERUN DESIGNATION TO PANEL.
- B. WHERE ITEMS ARE NOTED AS BEING RELOCATED, REINSTALL SALVAGED EQUIPMENT IN NEW LOCATION SHOWN. EXTEND AND RECONNECT TO EXISTING CIRCUIT, UON.
- C. WIRING NOT SHOWN FOR CLARITY, BUT SHALL BE PROVIDED BY CONTRACTOR TO MEET NEC REQUIREMENTS PER THE CIRCUIT ASSIGNMENTS INDICATED.
- D. UON, PROVIDE 2#12, 1#12 GND FOR ALL 15 AND 20A/1P CIRCUITS. SEE SHEET FOR HOMERUN DESIGNATIONS.

#### SHEET NOTES:

- NEW SERVICE ENTRANCE EQUIPMENT. COORDINATE WITH UTILITY. SEE 2/E601.
- 2. PROVIDE 120VAC ELECTRICAL CIRCUIT FOR NEW FIRE ALARM BELL.
- PROVIDE NEW GFCI RECEPTACLE AND MOUNT +18" AFF AND CONNECT WITH NEW CIRCUITRY TO EXISTING RECEPTACLE CIRCUIT.
- RECESSED DUPLEX RECEPTACLE FOR CONNECTION TO AV IN-WALL SENSOR. COORDINATE WITH EXHIBIT CONTRACTOR.
- 5. PROVIDE 120V CONNECTION TO ADA DOOR OPERATORS AND PUSHBUTTONS. SEE ARCHITECTURAL FOR PUSHBUTTON LOCATIONS.
- PROVIDE NEW POWER RECEPTACLE AND CONNECT TO SALVAGED CIRCUIT. EXTEND AND CONNECT CIRCUITRY.
- 7. PROVIDE NEW QUAD RECEPTACLE AND CIRCUIT FOR CEILING PROJECTOR.
- 8. COORDINATE RECEPTACLE LOCATIONS WITH FURNITURE LAYOUT. PRIOR TO ROUGH-IN.
- PROVIDE NEW JUNCTION BOX FOR RELOCATED SECURITY KEYPAD AND CONNECT TO SALVAGED CIRCUIT. EXTEND AND RECONNECT CIRCUITRY.
- 10. CONNECT TO LOCAL LIGHTING CIRCUIT. SEE 1/E201.
- 11. RELOCATE RECEPTACLE +42" ABOVE CABINETS. SEE GENERAL NOTE 'B'.
- 12. LOCATE RECEPTACLE ON SECOND STORY WALL BEHIND PAST & PRESENT MONITOR. COORDINATE LOCATION PRIOR TO ROUGH IN.
- 13. PROVIDE NEW 120V CIRCUIT FOR NEW FIRE ALARM PANEL.
- 14. PROVIDE NEW GFCI RECEPTACLE AND 120V CIRCUIT AT +48" AFG. PER
- 15. CEILING MOUNTED RECEPTACLE FOR AV SENSOR. COORDINATE WITH EXHIBIT CONTRACTOR.

DESIGNED: SUB SHEET NO. CADD. MJC TECH REVIEW CPL DATE: 2016.09.28

TITLE OF SHEET POWER REMODEL PLAN -FIRST FLOOR


> SEWARD VISITOR CENTER REHAB KENAI FJORDS NATIONAL PARK

PMIS/PKG NO. 184638 SHEET 65 OF 73

DRAWING NO

80,040

E301

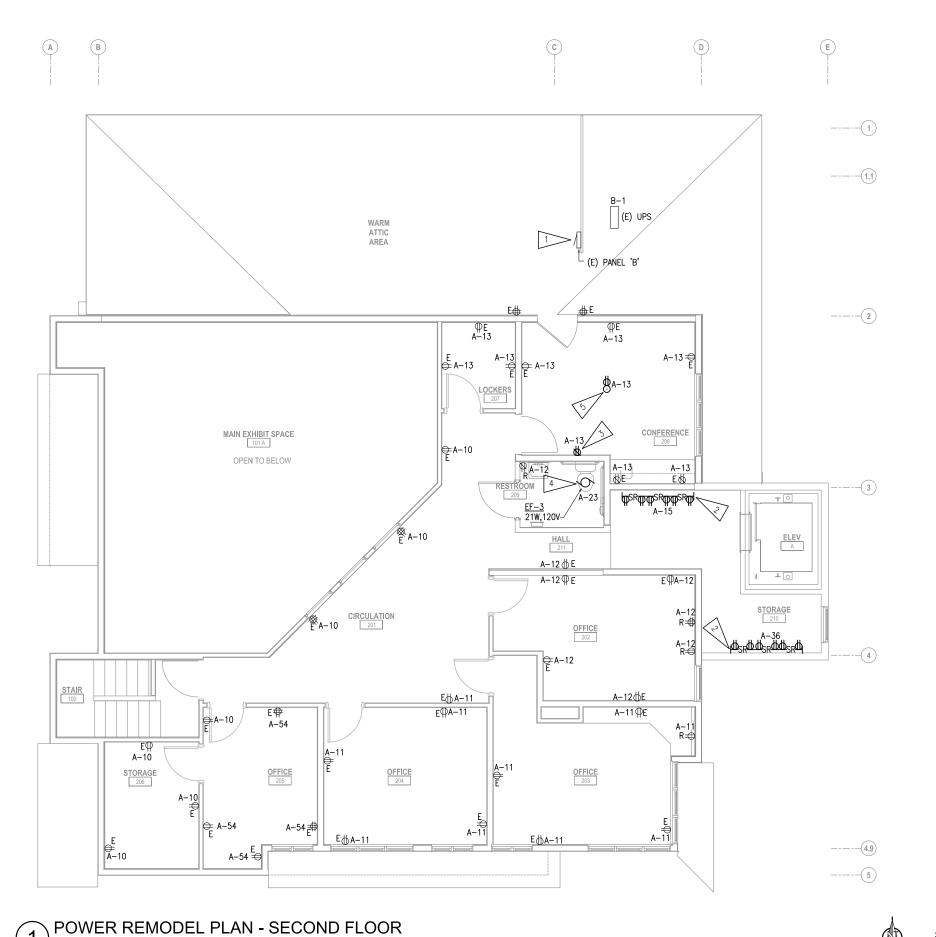

- A. SEE GENERAL NOTES E301.
- B. DESIGN INTENT FOR CIRCUITING ON SECOND FLOOR IS TO LEAVE EXISTING CIRCUITRY AND CIRCUIT LOADING WHERE POSSIBLE AND JUST EXTEND TO NEW PANEL. CIRCUIT ASSIGNMENTS SHOWN ARE PER THE ORIGINAL CONTRACT DOCUMENTS.

#### SHEET NOTES:

- EXTEND AND RECONNECT EXISTING LOAD CENTER TO NEW PANEL 'A'. SEE 2/E601.
- 2. PROVIDE NEW SURFACE RACEWAY AND RECEPTACLES. MOUNT +44" AFF.
- 3. PROVIDE NEW GFCI RECEPTACLE AND CONNECT TO SALVAGED CONDUCTORS. EXTEND AND RECONNECT TO SALVAGED CIRCUIT.
- PROVIDE NEW CIRCUITRY AND CONNECT TO LOCAL LIGHTING CIRCUIT. SEE 1/E202.
- 5. PROVIDE NEW CIRCUITRY AND CONNECT TO LOCAL RECEPTACLE CIRCUIT.
  COORDINATE LOCATION WITH CONTRACTING OFFICER, PRIOR TO
  ROLLOLLIN

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Corporate No.: AECCSA.



DESIGNED:	SUB SHEET NO.
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CPL	
DATE:	


POWER REMODEL PLAN -SECOND FLOOR

> SEWARD VISITOR CENTER REHAB KENAI FJORDS NATIONAL PARK

80,040 PMIS/PKG NO. 184638 SHEET

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DRAWING NO.

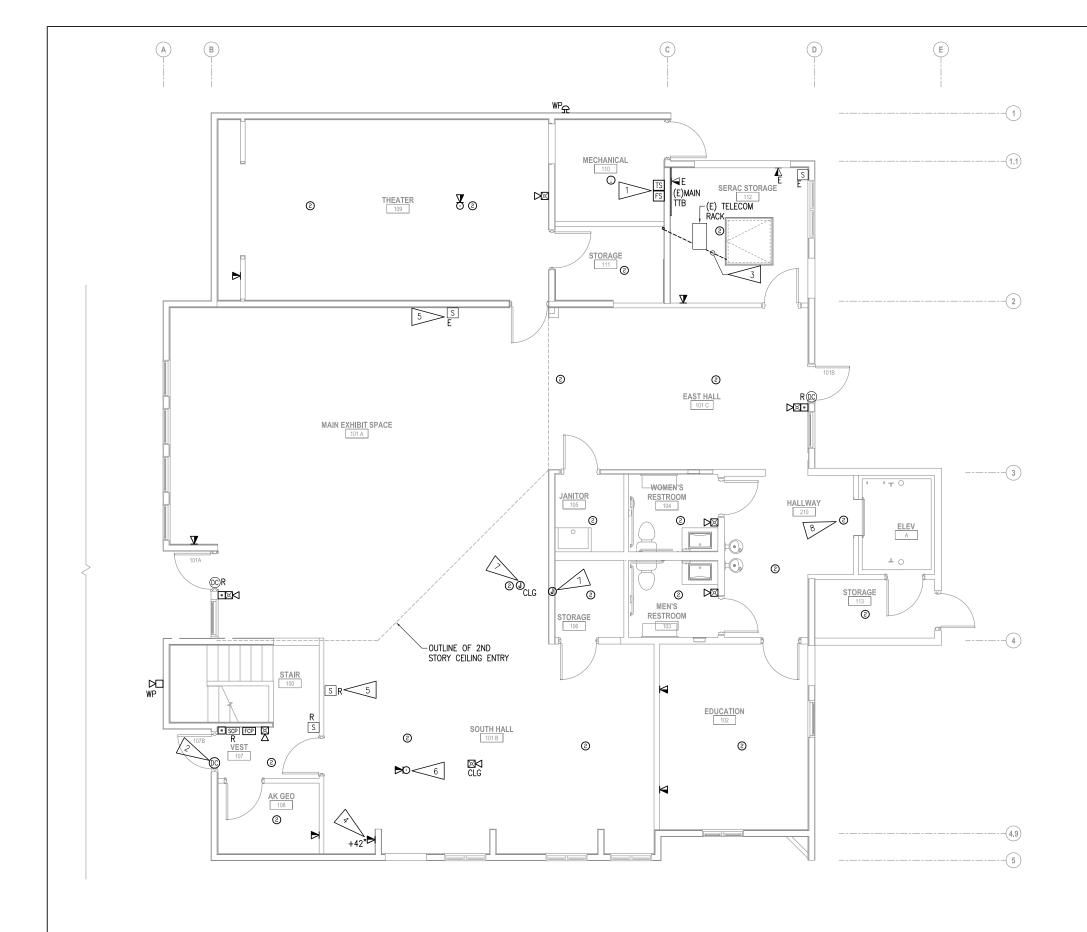

- A. WHERE ITEMS ARE NOTED AS BEING RELOCATED, REINSTALL SALVAGED EQUIPMENT IN NEW LOCATION SHOWN. EXTEND AND RECONNECT TO EXISTING CIRCUIT, UON.
- B. SEE 1/E602 FIRE ALARM ONE-LINE DIAGRAM.
- C. PROVIDE ROUGH-IN ONLY FOR ALL NEW TELECOMMUNICATION BOXES SHOWN. ALL OTHER TELECOMMUNICATION UPGRADES SHALL BE PERFORMED BY NPS. SEE 3/E701 TELECOM ROUGH-IN DETAIL.

#### SHEET NOTES

- 1. COORDINATE NUMBER AND LOCATION OF FLOW AND TAMPER SWITCHES WITH SPRINKLER CONTRACTOR PRIOR TO ROUGH-IN.
- 2. PROVIDE NEW DOOR CONTACT THAT IS COMPATIBLE WITH EXISTING SECURITY PANEL AND CONNECT TO SECURITY PANEL. SEE 2/E602 SECURITY ONE-LINE
- PROVIDE EMPTY CONDUIT FROM CRAWL SPACE, THROUGH NORTHEAST CORNER OF STORAGE 111 THEN TO ATTIC. NPS TO PROVIDE DATA CABLES. PRIOR TO ROUGH—IN COORDINATE SIZE OF CONDUIT WITH NPS. ASSUME 3" CONDUIT FOR BIDDING PURPOSES. SEE 3/E701.
- 4. TELECOM JACK FOR PHONE.
- 5. MOUNT SECURITY AREA DETECTOR CENTERED WITHIN BLACK BAND.
- 6. COORDINATE RECEPTACLE LOCATIONS WITH FURNITURE LAYOUT. PRIOR TO ROUGH-IN.
- 7. PROVIDE 1" CONDUIT WITH PULLSTRING FROM AV SPEAKER TO THEATER AV RACK. COORDINATE WITH EXHIBIT CONTRACTOR.
- 8. SMOKE DETECTOR FOR ELEVATOR RECALL.

DESIGNED:	SUB SHEET NO.
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TECH REVIEW:	F401
CPL	L-70 I
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SIGNAL REMODEL PLAN -FIRST FLOOR

TITLE OF SHEET


SEWARD VISITOR CENTER REHAB KENAI FJORDS NATIONAL PARK

PMIS/PKG NO. 184638 SHEET 67 of 73

DRAWING NO

80.040

SIGNAL REMODEL PLAN - FIRST FLOOR

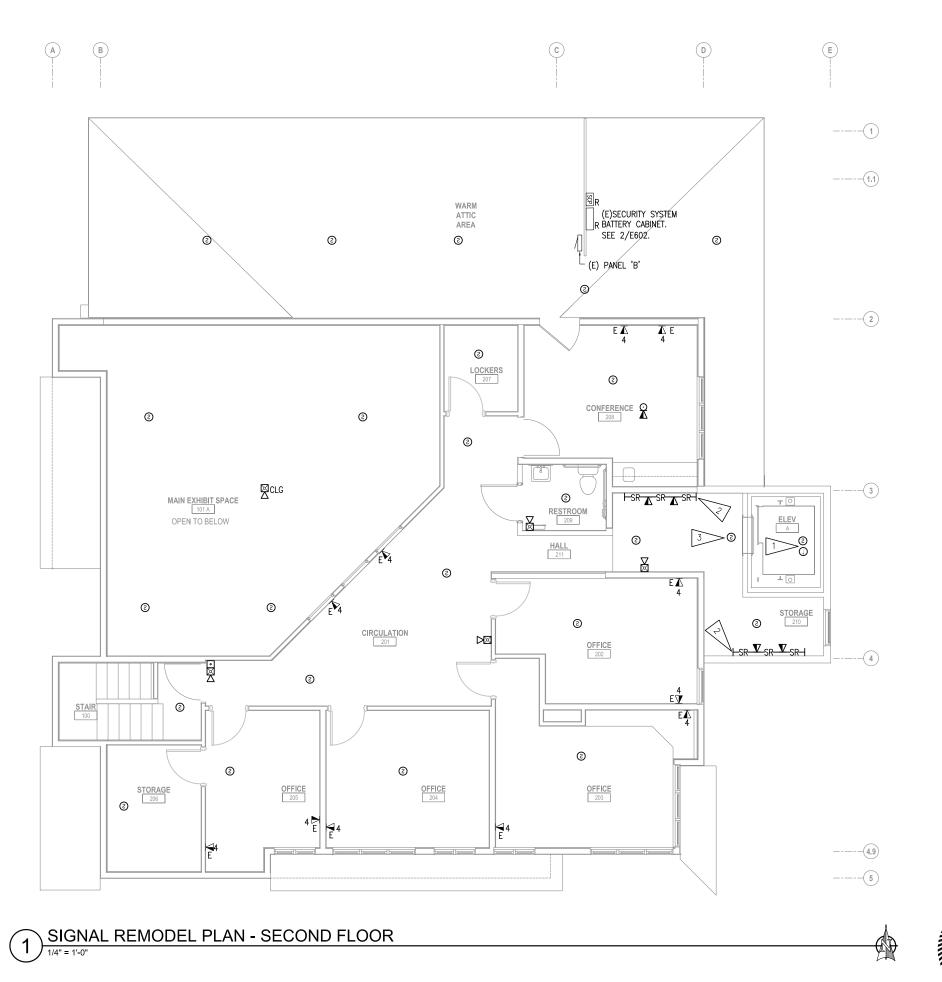

A. SEE SHEET E401 FOR GENERAL NOTES.

#### SHEET NOTES:

- LOCATE SMOKE AND HEAT DETECTORS AT THE TOP OF THE ELEVATOR SHAFT.
- PROVIDE NEW SURFACE RACEWAY AND ROUGH—IN FOR TELECOM OUTLETS. MOUNT +44" AFF.
- 3. SMOKE DETECTOR FOR ELEVATOR RECALL.


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Corporate No.: AECC542 - RSA Jobbt L525



SIGNAL REMODEL PLAN -SECOND FLOOR

SEWARD VISITOR CENTER REHAB KENAI FJORDS NATIONAL PARK PMIS/PKG NO. 184638 SHEET 68 OF 73

DRAWING NO.

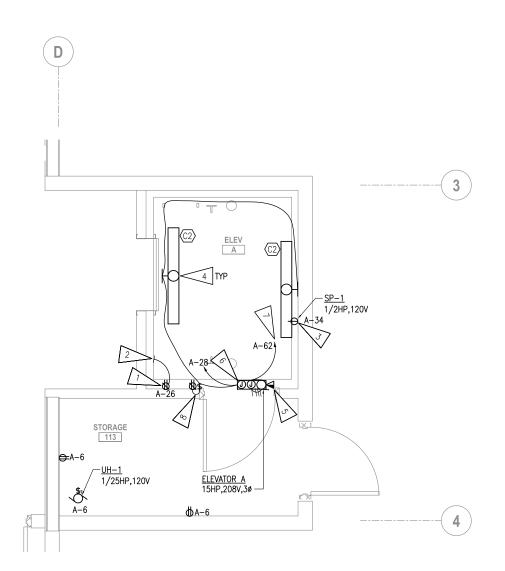

ENLARGED POWER & SIGNAL REMODEL PLAN - ELEVATOR



A. SEE GENERAL NOTES E301

#### SHEET NOTES:

- 1. GFCI RECEPTACLE LOCATED IN ELEVATOR PIT.
- 2. CONNECT CIRCUIT TO ELEVATOR PIT LIGHT. SEE 1/E201.
- 3. RECEPTACLE FOR SP-1 LOCATED IN ELEVATOR PIT.
- 4. MOUNT FIXTURES ABOVE LANDING DOOR. COORDINATE WITH ELEVATOR SHOP DRAWINGS PRIOR TO ROUGH-IN.
- 5. PROVIDE A DEDICATED PHONE LINE FOR ELEVATOR.
- 6. PROVIDE CONNECTION TO "MACHINE ROOM-LESS" ELEVATOR CONTROLLER. PROVIDE SINGLE POINT CONNECTION FOR MAIN TO ELEVATOR CONTROLLER AND A SECOND DEDICATED 20A, 120V BRANCH CIRCUIT FOR THE ELEVATOR CAB LIGHTS, CAB VENTILATION ETC. ELEVATOR CONTROLLER FURNISHED WITH MAIN FEEDER LINE DISCONNECT AND ELEVATOR CAB DISCONNECT.
- 7. ROUTE MAIN POWER FEED TO PANEL 'A' IN MECHANICAL 110. SEE 2/E601 FOR FEEDER SIZE.
- 8. COORDINATE LOCATION WITH ELEVATOR MANUFACTURER SHOP DRAWINGS PRIOR TO ROUGH-IN.



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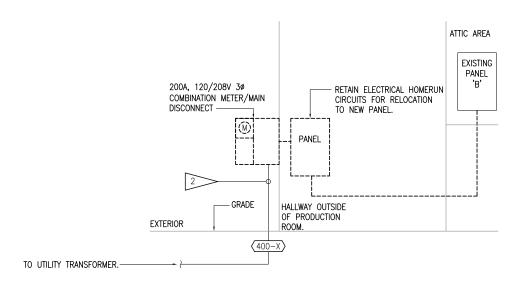
ENLARGED POWER & SIGNAL REMODEL PLAN -FIRST FLOOR SEWARD VISITOR CENTER REHAB

TITLE OF SHEET

PMIS/PKG NO. 184638 SHEET KENAI FJORDS NATIONAL PARK

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DRAWING NO.



# 1 ELECTRICAL ONE-LINE DIAGRAM - DEMOLITION

FEEDER SCHEDULE

FEEDER COND. BRKR SIZE 3 PHASE CONDUCTORS, NEUTRAL AND GROUND (TAG #100-4, FOR EXAMPLE)


(400-X) - (E) 3"C, 4#4/0 SERVICE LATERAL CONDUCTORS

(60-3) 70A 60 1.25C, 3#4, 1#10 GND.

(90-3) 55A 90 1.25C, 3#6, 1#8 GND.

(100-4) 115A 100A 1.25"C, 4#2, 1#8 GND.

(400-4) 380A 400A 4"C, 4#500kcmil, 1#1/0 GND.

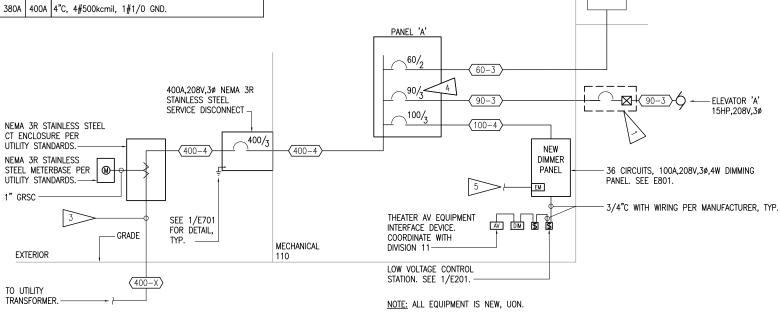

# 2 ELECTRICAL ONE-LINE DIAGRAM - REMODEL

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Comprate No.



ATTIC AREA

EXISTING

PANEL

TITLE OF OTHER
<b>ELECTRICAL ONE-LINI</b>
DIAGRAMS

TITLE OF SHEET

SHEET NOTES:

TO NEW CT'S.

ELEVATOR CONTROLLER FURNISHED WITH SINGLE POINT

2. COORDINATE WITH LOCAL UTILITY COMPANY TO DISCONNECT EXISTING SERVICE LATERAL CONDUCTORS AND

EXISTING 3" CONDUIT FROM DEMOLISHED SERVICE ENTRANCE METER/MAIN COMBO AND SALVAGE FOR RECONNECTION TO NEW CT CABINET. SEE 2/E601.

3. RECONNECT SALVAGED 3" CONDUIT TO NEW CT CABINET AND COORDINATE WITH LOCAL UTILITY COMPANY TO RE-CONNECT SALVAGED SERVICE LATERAL CONDUCTORS

PROVIDE EMERGENCY BYPASS RELAY FOR EM LIGHTING IN

4. COORDINATE BREAKER SIZE WITH ELEVATOR MANUFACTURER PRIOR TO ORDERING.


SALVAGE FOR RECONNECTION TO NEW CT'S. DISCONNECT

CONNECTION MAIN FEEDER LINE DISCONNECT.

SEWARD VISITOR CENTER REHAB KENAI FJORDS NATIONAL PARK PMIS/PKG NO. 184638

SHEET


70 OF 73

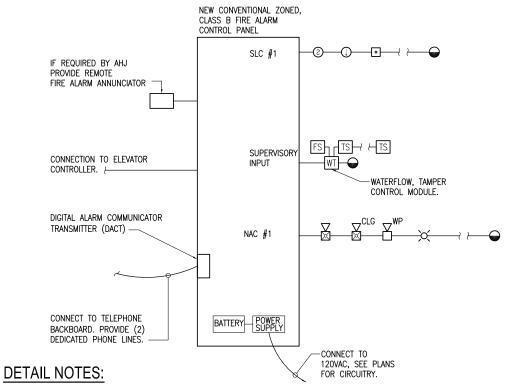

- 1. SEE POWER AND SIGNAL SHEETS FOR NUMBER AND LOCATION OF ALL FIRE ALARM EQUIPMENT, DEVICES, ETC.
- 2. SIZE CONDUIT AND WIRES IN ACCORDANCE WITH FIRE ALARM SYSTEM MANUFACTURER RECOMMENDATIONS AND SPECIFICATIONS.
- 3. COORDINATE INSTALLATION OF SMOKE DETECTORS WITH AIR SUPPLY AND RETURN DIFFUSERS TO MAINTAIN MINIMUM 36" SEPARATION PER NFPA 72 REQUIREMENTS.

FIRE ALARM ONE-LINE DIAGRAM

4. EXACT NUMBER OF FLOW AND TAMPER SWITCHES TO BE DETERMINED BY SPRINKLER SUPPLIER. FIELD COORDINATE WITH SPRINKLER INSTALLER PRIOR TO BIDDING FOR NUMBER AND LOCATION OF TAMPER AND FLOW SWITCHES.

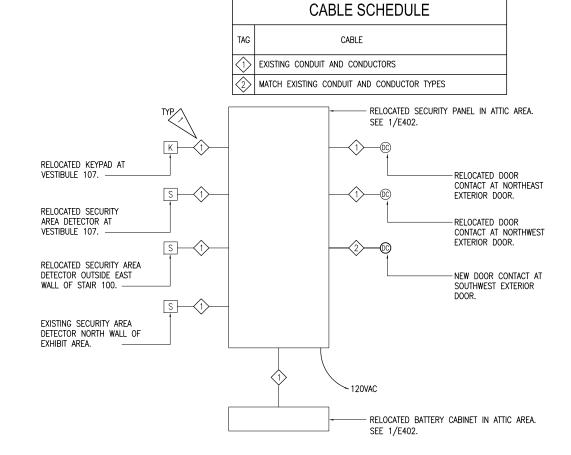

SECURITY SYSTEM

SECURITY SYSTEM ONE-LINE DIAGRAM

SEE PLANS FOR QUANTITIES AND LOCATIONS OF ALL SECURITY SYSTEM DEVICES.

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Compared No. 4


DESIGNED: MJC CADD: MJC CADD: MJC TECH REVIEW: CPL DATE: 2016.09.28

FIRE ALARM & SECURITY
ONE-LINE DIAGRAMS


SEWARD VISITOR CENTER REHAB KENAI FJORDS NATIONAL PARK 186 80,040 PMIS/PKG NO. 184638 SHEET

71 of 73

DRAWING NO.

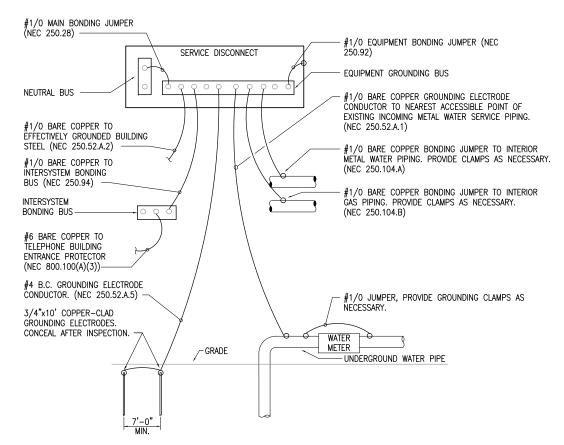


# 1 SERVICE GROUNDING DETAIL

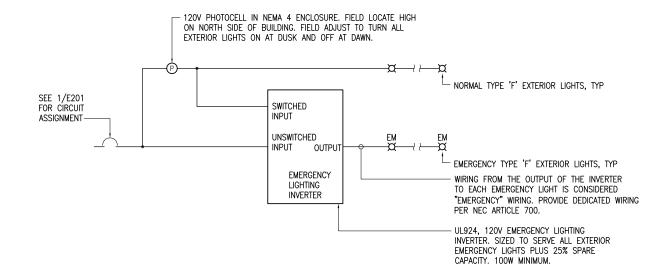


EMERGENCY EXTERIOR LIGHTING DETAIL

ALL TELECOMMUNICATION EQUIPMENT AND CABLES GOVERNMENT FURNISHED AND GOVERNMENT INSTALLED

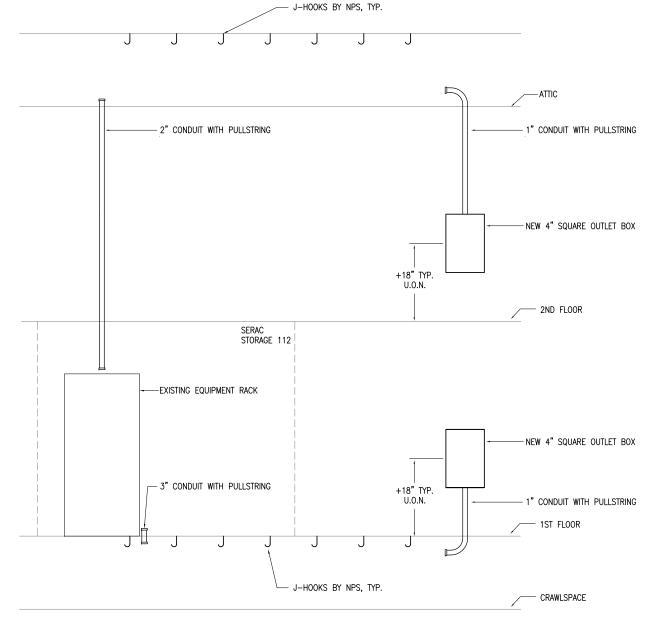



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DETAILS

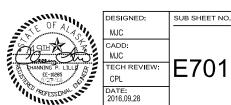SEWARD VISITOR CENTER REHAB KENAI FJORDS NATIONAL PARK

TITLE OF SHEET

PMIS/PKG NO. 184638

SHEET

72 OF 73

drawing no.

MFR/MODEL: SQUARE 'D' TYPE NQ						VOLTS:	120/208	V,3PH,4\	Ν		ENCL	OSURE: NEMA 1 400					
MTG SPACE: AS REQUIRED								VOLT-A	MPS			MTG: SURFACE					
CIRC	POLE	00774	STIME	SERVICE	TYPE	E A B		С		TYPE	SERVICE	AMPS	POLE	CIRC	NOTE		
1	1			RECP EXHIBT101,THEATER109.	RECP	1080	720					MISC	RECP MECH 110	20	1	2	+
3	1	-	-	RECP EXT, SERAC STO 112	RECP			720	720			RECP	RECP RR103,4 JAN105,STO106	20	1	4	$\perp$
5	1	2	0	RECP STORAGE 111	RECP					900	816	MISC	RECP RM113,114, EWC, UH-1	20	1	6	$^{\dagger}$
7	1			RECP ED102 EXHBT101, EXT	RECP	1260	720						RECP EXHIBIT 101	20	1	8	T
9	1			RECP GEO108, VEST107 EX	RECP			1080	1620			RECP	RECP OFF205,STO206 CIR201	20	1	10	t
11	1	2	0	RECP OFF203,204,CIR201	RECP					1800	1620	RECP	RECP OFF202, CIR201, RR209	20	1	12	T
13	1	2	0	RECP CONF 208, LOCK 207	RECP	1800	135		1			LTG	LTG ATTIC LIGHTS	20	1	14	T
15	1	+-	-	RECP SR IN CIRC 201	RECP			1080	136				LTG RM 101,106,107	20	1	16	t
17	1	2	0	LTG RM102-106,113,114,EF-1,2,4	LTG					489	292		LTG RM 110,111,112	20	1	18	T
19	1			NORTHWEST ADA OPERATOR	MISC	500	66		1				LTG EXTERIOR WALL LIGHTS	20	1	20	
21	1	+-	-	LTG CRAWLSPACE	LTG			108	521				LTG OFFICE 202, 203, 204	20	1	22	-
23	1	-	-	LTG RM 207-209, EF-3 RM209						308	754	-	LTG STAIR, CIRC201, OFF205, STO206	20	1	24	
25	1	+	-	CP-2 MECH 110	MOTR	864	260		ı				ELEVATOR PIT LGHT & RECP	20	1	26	+
27	1	-	-	EXTERIOR F/A BELL	MISC	001	200	500	260				ELEVATOR CAB LGHT & RECP	20	1	28	-
29	1	+	-	FIRE ALARM CIRCUIT	MISC			000	200	500	426		CP-3. CP-4 VF-1 MECH 110	15	1	30	-+-
31	1	+-	-	OAS & ODB & RADIO	MISC	540	720			000	720	and the latest territories of the latest territories.	INFORMATION DESK POPS	20	1	32	
33	1	-	$\rightarrow$	B-1 MECH 110	MOTR	0.10	720	900	1176				SP-1 ELEVATOR SUMP PIT	20	1	34	-
35	1	+-	-	RECP TELECOM RACK	RECP	0		500	1110	360	1080			20	1	36	-+
37	1			RECP TTB	RECP	360	500		- 1	300	1000	and the latest department	NORTHEAST ADA OPERATOR	20	1	38	
39	1	-	orași de	SECURITY KEYPAD	MISC	300	500	500	432				CP-1 MECH 110	15	1	40	-+
41	1	+		SPARE	MISC			500	432		2000	101.00.111.0	OUTSIDE SHOP OUTLET	30	2	42	
43	1	+-	-	SPARE			2000		- 1		2000	SPEC	AA	30	2	44	-
45	1	-	-	ISTI & RSAI	MISC		2000	720	660			eraleismenteleten	HRV-1 MECH 110	15	1	46	-
47	1	-	-	LANDSCAPE P&P	MISC			720	000	360	360		FF&FAS, CWFWI	20	1	48	-
49	1	4	-	CEILING PROJ THEATER 109	MISC	500	180		- 1	300	300	representative between the properties	RECP FLOOR THEATER 109	20	1	50	-
51	1			AV RACKS THEATER 109	MISC	300	100	500	500			MISC	AV RACKS THEATER 109	20	1	52	
53	1			RECP EXT SERVICE ENT.	RECP			300	300	180	1080		RECP OFFICE 205	20	1	54	
55	1			SPARE	KLOF				- 1	100	1000	KLCF	SPARE	20	1	56	
57	1	-	-	SPARE									SPARE	20	1	58	
59	1			SPARE									SPARE	20	1	60	
61	1			SPARE			5800		- 1			MOTE	ELEVATOR		3	62	-
63	1	-	-	SPARE			0000		5800						3	64	
65	1	+	description of the last	SPARE		3			0000		5800	MOTR			3	66	
67	3	-	-	EXISTING PANEL 'B'	FEDR	3304	7884		- 1		0000	-	NEW DIMMER PANEL		3	68	
69	3			۸۸۸	FEDR			2000	6475			FEDR	۸۸۸		3	70	
71	3			^^^	FEDR					1000	6859	FEDR	۸۸۸	•	3	72	
				TOTAL V-A	***************************************		29193	T	26408		26984		82,585	VA			*
				TOTAL AMPS			243	1	220		225		229	Α			_
			А١	VAILABLE FAULT CURRENT :	9,253	A	AIC F	RATING:	10,000							_	_
					LTG	REC	MOTR	LG MTR	MISC	KIT	HEAT	SPEC	TOTAL	1	AMP	S	_
CONNECTED LOAD IN KVA (THIS PANEL) 2.81					2.81	17.64	21.86	4.35	8.76	0.00	0.00	4.00	55.1 KVA		153		7
					21.22	0.00	0.00	0.00	6.30	0.00	0.00	0.00	27.5 KVA		76	,	
		TO:	ΓAL	CONNECTED LOAD IN KVA:	24.03	17.64	21.86	4.35	15.06	0.00	0.00	4.00	82.6 KVA		229	,	7
				DEMAND LOAD IN KVA:	30.03	13.82	21.86	4.35	15.06	0.00	0.00	4.00	89.1 KVA		247	6	
SE	OR	OV	/EF	R ONE-LINE FOR BREAKER SIZE E BREAKER SIZE WITH ELEVA ED HANDLE BREAKER, CAPA	ATOR M							-	OPTIONS: LUGS ONLY				

1 3 5 7 9 1 3 5 7 9		20 20 20 20 20 20 20 20 20	SERVICE  E01-TRACK(NW) 1 OF 3  E03-TRACK(NW) 3 OF 3  E05-TRACK(S) 1 OF 3  E07-TRACK(S) 3 OF 3  E09-TRACK LOW(E)  E11-TRACK HIGH(N) 1 OF 6  E13-TRACK HIGH(MID) 3 OF 6  E15-TRACK HIGH(MID) 5 OF 6	TYPE LTG LTG LTG LTG LTG LTG LTG LTG	1050	1050 975	1050	AMPS B	1200	1200	TYPE LTG LTG	SERVICE  SERVICE  E02-TRACK(NW) 2 OF 3  E04-TRACK(SE)	20 20 20	1 1	2 4 6	a,b a,b
1 3 5 7 9 1 3 5 7 9	1 1 1 1 1 1 1 1 1 1	20 20 20 20 20 20 20 20 20 20	E01-TRACK(NW) 1 OF 3 E03-TRACK(NW) 3 OF 3 E05-TRACK(S) 1 OF 3 E07-TRACK(S) 3 OF 3 E09-TRACK LOW(E) E11-TRACK HIGH(N) 1 OF 6 E13-TRACK HIGH(MID) 3 OF 6 E15-TRACK HIGH(S) 5 OF 6	LTG LTG LTG LTG LTG LTG LTG	1725	1050	1050				LTG LTG	E02-TRACK(NW) 2 OF 3 E04-TRACK(SE)	20 20	1	2	a,b
1 3 5 7 9 1 3 5 7 9	1 1 1 1 1 1 1 1 1 1	20 20 20 20 20 20 20 20 20 20	E03-TRACK(NW) 3 OF 3 E05-TRACK(S) 1 OF 3 E07-TRACK(S) 3 OF 3 E09-TRACK LOW(E) E11-TRACK HIGH(N) 1 OF 6 E13-TRACK HIGH(MID) 3 OF 6 E15-TRACK HIGH(S) 5 OF 6	LTG LTG LTG LTG LTG LTG	1725			1200	1200	1200	LTG	E04-TRACK(SE)	20 20	1	2	a,b
5 7 9 1 3 5 7 9	1 1 1 1 1 1 1 1 1 1	20 20 20 20 20 20 20 20	E05-TRACK(S) 1 OF 3 E07-TRACK(S) 3 OF 3 E09-TRACK LOW(E) E11-TRACK HIGH(N) 1 OF 6 E13-TRACK HIGH(MID) 3 OF 6 E15-TRACK HIGH(S) 5 OF 6	LTG LTG LTG LTG LTG		975		1200	1200	1200						a,b
7 9 1 3 5 7 9	1 1 1 1 1 1	20 20 20 20 20 20 20	E07-TRACK(S) 3 OF 3 E09-TRACK LOW(E) E11-TRACK HIGH(N) 1 OF 6 E13-TRACK HIGH(MID) 3 OF 6 E15-TRACK HIGH(S) 5 OF 6	LTG LTG LTG LTG		975			1200	1200			20	4	0	
9 1 3 5 7 9	1 1 1 1 1 1 1	20 20 20 20 20	E09-TRACK LOW(E) E11-TRACK HIGH(N) 1 OF 6 E13-TRACK HIGH(MID) 3 OF 6 E15-TRACK HIGH(S) 5 OF 6	LTG LTG LTG		975				1200	LIG	E06-TRACK(S) 2 OF 3	20	-	ь	a,b
1 3 5 7 9	1 1 1 1 1	20 20 20 20	E11-TRACK HIGH(N) 1 OF 6 E13-TRACK HIGH(MID) 3 OF 6 E15-TRACK HIGH(S) 5 OF 6	LTG LTG							LTG	E08-TRACK(SW)	20	1	8	a,b
3 5 7 9	1 1 1 1	20 20 20	E13-TRACK HIGH(MID) 3 OF 6 E15-TRACK HIGH(S) 5 OF 6	LTG	-		825	1275			LTG	E10-TRACK LOW(W)	20	1	10	a,b
5 7 9	1 1 1	20 20	E15-TRACK HIGH(S) 5 OF 6						2250	1875	LTG	E12-TRACK HIGH(N) 2 OF 6	20	1	12	a,b
7 9	1	20			1875	1125					LTG	E14-TRACK HIGH(SE) 4 OF 6	20	1	14	a,b
9	1			LTG			1125	750			LTG	E16-TRACK HIGH(S) 6 OF6	20	1	16	a,b
1	-	00	E17-E19 DEC PENDS(S)	LTG					57	80	LTG	E20-E22 SURFACE MNT DEC	20	1	18	С
	1	20	E24,E25 WAVELGHT PROJ(E)	LTG	30	30					LTG	E25-E27 WAVELGT PROJ(NE)	20		20	С
3		20	E28-MICROSPOTS(NE)	LTG			75	175			LTG	THEATER CAN LIGHTS	20		22	d
_	1	20	THEATER DECORATIVE PEN	LTG					81	116	LTG	EMERGENCYLIGHTS	20	1	24	е
5	1	20	THEATER LIGHTS FRONT	LTG	24							SPARE	20	1	26	
7	1	20	SPARE									SPARE	20			
9	1	_	SPACE									SPACE	-			
1	1	4	SPACE					0.2				SPACE	-			
3	1	-	SPACE									SPACE	-			
5	1	2	SPACE						d			SPACE	-	1	36	
			TOTAL V-A			7884		6475		6859		21,218	VA			-
			TOTAL AMPS			66		54		57		59	Α			
			A.I.C. RATING: 10,000					0.5								
									KIT				F			
COL																
	7	OTA			0.00		0.00	0.00	0.00	0.00	0.00	21.2 KVA				-
			DEMAND LOAD IN KVA:	26.52	0.00	0.00	0.00	0.00	0.00	0.00				74	Α	
RO IV. OAI HO RO XH RO	VIDE 11. D IN WN VIDE IBIT	DICA FOR E 20A CON E 20A	TED IS PER NEC 220.43(B) AND THE FEEDER AND SERVICE LIA A DIMMER, FULLY COMPATIBLE TRACT. A DIMMER, FULLY COMPATIBLE	O IS NO OAD CA WITH	T INTENIALCULATION	ED TO LI TIONS. FIXTUR	MIT TRA	CK LENG ISHED UI VED.	STH, IT IS	T(00)113();						
7 9 1 3 5 C F F C F F F F F	NO V. A HO RO CH RO RO	ONNE T T NOTE: ROVIDE R	ONNECTE: TOTA  ONNECTE: TOTA  NOTES: ROVIDE 20/V V.11. JAD INDICA HOWN FOR ROVIDE 20/V ROV	1 20 SPARE 1 - SPACE 1 - SPACE 1 - SPACE 3 1 - SPACE 5 1 - SPACE 5 1 - SPACE 6 1 - SPACE 7 TOTAL V-A TOTAL AMPS A.LC. RATING: 10,000  ONNECTED LOAD IN KVA (THIS PANEL): TOTAL CONNECTED LOAD IN KVA: DEMAND LOAD IN KVA: NOTES: ROVIDE 20A DIMMER, FULLY COMPATIBLE V. 11. ADDINDICATED IS PER NEC 220.43(B) ANI HOWN FOR THE FEEDER AND SERVICE LI ROVIDE 20A DIMMER, FULLY COMPATIBLE KHIBIT CONTRACT. ROVIDE 20A DIMMER, FULLY COMPATIBLE	1   20   SPARE	1   20   SPARE	1   20   SPARE	1   20   SPARE	1   20   SPARE	1	1   20   SPARE	1   20   SPARE	1   20   SPARE	1   20   SPARE	1   20   SPARE	1   20   SPARE

MFR/MODEL: UNKNOWN							120/208	V,3PH,4\	W		ENCLO	OSURE: NEMA 1 100 A						
No. No. No. 100								VOLT-A	AMPS	,		MTG:	SURFACE					
NO.	CIRC	POLE	AMPS	SERVICE	TYPE	,		Е	3		С	TYPE	SERVICE	AMPS	POLE	CIRC	NOTE	
3	1	1	30	UPS	MISC	2304	1000					MISC	UNKNOWN	20	1	2	8	
3	3	1	20	UNKNOWN	MISC			1000	1000			MISC	UNKNOWN	20	1	4	1	
T	5	1	-	SPACE	0						1000	MISC	UNKNOWN	20	1	6	1	
T	7	1		SPACE									SPACE	-	1	8	Γ	
T	9	1		SPACE									SPACE	-	1	10	Γ	
1	11	1		SPACE									SPACE	-	1	12	Т	
1	13	1		SPACE									SPACE	-	1	14	Г	
T	15	1		SPACE									SPACE		1	16	Г	
1	17	1		SPACE									SPACE		1	18	Γ	
T	19	1	-	SPACE							,		SPACE	-	1	20	Г	
1	21	1	-	SPACE								Ĭ Ĵ,	SPACE	-	1	22	Г	
				TOTAL V-A			3304		2000		1000		6,304	1 VA				
				TOTAL AMPS			28		17		8		17	7 A			Т	
				A.I.C. RATING: 10,000							7.2						Т	
					LTG	RECP	MOTR	LG.MT	MISC	KIT	HEAT	SPEC	TOTAL	1 7	AMP	S		
	CC	NNE	CTE	D LOAD IN KVA (THIS PANEL):	0.00	0.00	0.00	0.00	6.30	0.00	0.00	0.00	6.3 KVA		17	Α		
				0.00	0.00	0.00	0.00	6.30	0.00	0.00	0.00	6.3 KVA		17	Α			
DEMAND LOAD IN KVA: 0.00					0.00	0.00	0.00	0.00	6.30	0.00	0.00	0.00	6.3 KVA		17	A		

#### SHORT CIRCUIT CALCULATION SUMMARY

**NEW DIMMER PANEL 'DIM'** 

FAULT ANALYSIS WAS PERFORMED USING POINT-TO-POINT METHOD. THE FOLLOWING ARE THE UTILITY CONTRIBUTION AND EQUIPMENT ASSUMPTIONS:

AVAILABLE FAULT CURRENT AT UTILITY XFMR: INFINITE BUS
UTILITY TRANSFORMER SIZE: 150 KVA
UTILITY TRANSFORMER IMPEDENCE: 2.20 %

SERVICE LATERAL # PARALLEL RUNS: 1 EA.


SERVICE LATERAL SIZE: #4/0 KCMIL AI
SERVICE LATERAL LENGTH: 75 FEET

SERVICE LATERAL CONDUIT TYPE: METALLIC
TOTAL MOTOR CONTRIBUTIONS: 61 AMPS

AVAILABLE FAULT CURRENT AT MDP: 9253 A RMS (SYM)

NOTE: VERIFY THE ABOVE TRANSFORMER RATINGS AND SERVICE
LATERAL SIZE/TYPE WITH LOCAL UTILITY PRIOR TO ORDERING EQUIPMENT.
ADJUST EQUIPMENT SHORT CIRCUIT RATINGS ACCORDINGLY BASED ON ACTUAL
EQUIPMENT INSTALLED BY UTILITY. INSTALL LABEL ON SERVICE EQUIPMENT
INDICATING DATE AND FINAL CALCULATION RESULTS PER NEC 110.24.

RSA ENGINEERING, INC.
MECHANICAL AND ELECTRICAL CONSULTING ENGINEERS
670 West Freweed Lane, Suite 200 - Anchorage, AK 99503 - (907) 276-052
191 East Swanson Ave., Suite 101 - Wasilla, AK 99654 - (907) 357-152
Corporate No. AECC542

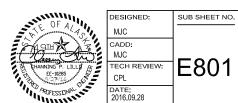

PANEL SCHEDULES

DRAWING NO.

186

80,040

PMIS/PKG NO.
184638

SHEET

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SEWARD VISITOR CENTER REHAB KENAI FJORDS NATIONAL PARK